


DEPARTMENT OF NATURAL RESOURCES
ADMIN. BUILDING - WATER SUPPLY
NETWORK REPLACEMENT
PROJECT #04206500



State of Utah—Department of Administrative Services

**DIVISION OF FACILITIES CONSTRUCTION
AND MANAGEMENT**

4110 State Office Building / Salt Lake City, Utah 84114 / 538-3018

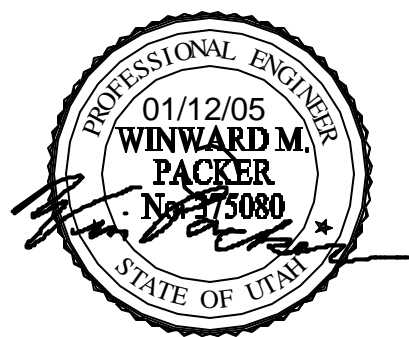

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WHW ENGINEERING, INC.
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DFCM DESIGN AND CODE CRITERIA

(Fee A/E: Attach and fill in applicable data for each drawing submittal)

Applicable Codes:	Year 2003	International Mechanical Code	Year 2003
International Building Code		International Plumbing Code	2003
Planning & Design Criteria to Prevent Architectural Barriers for the Aged and the Physically Handicapped.		Ashrae/IES Energy Code	1999
		National Electrical Code	2002

A. Occupancy and Group : B / S-1

Change In Use : Yes _____ No ☒ Mixed Occupancy : Yes ☒ No _____

B. Type of Construction (Circle) I F.R. II F.R. III 1 HR. III N IV H.T. V 1 HR. V N

C. Location on Property : F.R. Ext. Walls (Hrs.): N.R. Ext. Wall Opening(s) Protection (Hrs.) N.R. Each Occupancy

D. Occupancy separation required (Hrs.): B/R-2=2 HR

Sprinklered: Indicate Yes or No

Stories : 1 or multiple

a. Actual Area²(ft) 92,000 SF

b. Basic allowable area :

c. Allowable Area Increase due to side yards: N

d. Side yard area increase (ft):

Accumulative sub-total (b+d):

Sprinkler: area increase (x3 single)

(x 2 multi)

e. Total Allowable Area for a single

story:

x 2 for multi-story building:

f. Ratio = a/e

(Actual divided by allowable)

E. Fire-Resistive Requirements (Hrs.): (1 Hr., 2Hr., 3Hr., 4Hr., N. H.T.)

Exterior Bearing Walls: N Floors - Ceiling Floors N

Interior Bearing Walls: N Roofs - Ceiling Roofs N

Exterior Non-bearing Walls: N Exterior Doors and Windows NR

Structural Frame: N Shaft Enclosures 1 HR

Partitions - Permanent: N

(OCCUPANCY SEPARATION - N.A.)

DRAWING INDEX:

P-000	TITLE SHEET
P-001	PLUMBING GENERAL NOTES AND LEGEND
PD-101	FIRST FLOOR CULINARY WATER PIPING DEMOLITION PLAN
PD-102	SECOND FLOOR CULINARY WATER PIPING DEMOLITION PLAN
PD-103	THIRD FLOOR CULINARY WATER PIPING DEMOLITION PLAN
PD-201	ENLARGED CULINARY PIPING RESTROOM DEMO. PLANS
PD-501	CULINARY PIPING DEMOLITION DETAILS
PE-101	FIRST FLOOR NEW CULINARY WATER PIPING PLAN
PE-102	SECOND FLOOR NEW CULINARY WATER PIPING PLAN
PE-103	THIRD FLOOR NEW CULINARY WATER PIPING PLAN
PE-201	ENLARGED CULINARY PIPING RESTROOM PLANS
PE-501	CULINARY PIPING DETAILS
PE-502	CULINARY PIPING INSTALLATION DETAILS
PE-901	CULINARY WATER PIPING ISOMETRIC

D

C

B

A

MECHANICAL LEGEND					
SYMBOL	ABR.	DESCRIPTION	SYMBOL	ABR.	DESCRIPTION
GENERAL TERMINOLOGY			WET SIDE		
		SECTION LETTER DESIGNATION			ELBOW UP
		SECTION DRAWN ON THIS SHEET			ELBOW DOWN
		DETAIL NUMBER DESIGNATION			TEE UP
		DETAIL DRAWN ON THIS SHEET			TEE DOWN
		MECHANICAL EQUIPMENT DESIGNATION			EXISTING PIPING TO BE REMOVED
		EQUIPMENT ITEM DESIGNATION			EXISTING PIPING TO REMAIN
		REVISION DESIGNATOR AND NUMBER			NEW PIPING
		KEY NOTE DESIGNATOR AND NUMBER			PIPE CAP OR PLUG
	POC	POINT OF CONNECTION		D	DRAIN PIPING
	POR	POINT OF REMOVAL			UNION
GC		GENERAL CONTRACTOR			MANUAL ACTUATOR (BALL, BUTTERFLY, NEEDLE, ETC. VALVES)
MC		MECHANICAL CONTRACTOR			
EC		ELECTRICAL CONTRACTOR			FLANGES
NIC		NOT IN CONTRACT		BV	BALL VALVE SCREWED
NTS		NOT TO SCALE			CULINARY WATER COLD
C		COMMON			CULINARY WATER HOT
NC		NORMALLY CLOSED		MU	MAKE-UP WATER
NO		NORMALLY OPEN			

MECHANICAL GENERAL NOTES:

G-1 PLUMBING INFORMATION IS LIMITED TO THE DOCUMENTS.

A - EACH DRAWING SHEET AND THE SPECIFICATIONS HAVE BEEN PREPARED TO SUPPLEMENT EACH OTHER AND THEY SHALL BE INTERPRETED AS AN INTEGRAL UNIT WITH ITEMS SHOWN AND NOTED ON ONE AND NOT THE OTHER BEING FURNISHED AND INSTALLED AS THOUGH SHOWN AND CALLED OUT IN ALL PLACES. ITEMS IN SPECIFICATIONS OR DRAWINGS LISTED WHICH ARE DIFFERING IN EFFICIENCY OR QUALITY SHALL BE HELD TO THE GREATEST OF EFFICIENCY, QUALITY OR GOVERNING CODE.

B - THE CONTRACTOR WILL BE HELD RESPONSIBLE FOR THE INSTALLATION OF THE SYSTEMS ACCORDING TO THE TRUE INTENT AND MEANING OF THE CONTRACT DOCUMENTS.

C - THE CONTRACTOR SHALL INSTALL NEW PIPING, VALVES AND WATER HEATER WITH PROPER SERVICE ACCESS AND CLEARANCES ACCORDING TO MANUFACTURERS RECOMMENDATIONS. THE CONTRACTOR SHALL REVIEW SUPPLIERS BID PACKAGES FOR COMPLETENESS AND COMPLIANCE TO THE SPECIFICATIONS, SCHEDULES, AND DESIGN INTENT. THE CONTRACTOR SHALL REMOVE AND REINSTALL CORRECTLY AT HIS OWN EXPENSE ANY ITEMS NOT IN COMPLIANCE.

D - THE CONTRACTOR SHALL CONSULT MANUFACTURERS INSTALLATION INSTRUCTIONS FOR SIZES, ELECTRICAL REQUIREMENTS, METHODS, ACCESSORIES, AND CLEARANCES IN SPACE AVAILABLE PRIOR TO BIDDING PROJECT.

E - ANYTHING NOT CLEAR OR IN CONFLICT WILL BE EXPLAINED BY MAKING APPLICATION TO THE ENGINEER IN WRITING.

G-2 ANY AND ALL ALTERATIONS TO THE SYSTEM SHOWN SHALL BE THE RESPONSIBILITY OF THIS CONTRACTOR. ENGINEER SHALL BE NOTIFIED IN WRITING PRIOR TO ANY CHANGES.

G-3 CONTRACTOR SHALL FIELD VERIFY ALL DIMENSIONS AND LOCATIONS.

G-4 THE WORKING DRAWINGS ARE DIAGRAMMATIC. THEY DO NOT SHOW EVERY OFFSET, BEND, OR ELBOW NECESSARY FOR THE COMPLETE INSTALLATION IN THE SPACE PROVIDED. ALL LOCATIONS FOR PIPING, CONNECTIONS ETC. SHALL BE FIELD VERIFIED AND COORDINATED WITH ALL DRAWINGS.

G-5 THE INSTRUCTION TO "PROVIDE" ALSO INCLUDES INSTALLATION.


G-6 SUPPLIERS SHALL REVIEW ALL DRAWINGS AND THE SPECIFICATIONS PRIOR TO SUBMITTING PRICES TO THE CONTRACTOR. ALL QUESTIONS AND DISCREPANCIES SHALL BE BROUGHT TO THE ENGINEERS ATTENTION PRIOR TO BIDDING.

G-7 CONTRACTOR SHALL THOROUGHLY REVIEW AND SIGN SUBMITTALS FOR COMPLETENESS AND COMPLIANCE TO THE SPECIFICATIONS PRIOR TO ENGINEERS REVIEW. SUPPLIERS SHALL HIGHLIGHT OR MARK ALL INFORMATION REQUIRED TO SHOW COMPLIANCE TO THE SPECIFICATIONS. ALL REQUESTED EXCEPTIONS TO THE SPECIFICATIONS, OR SCHEDULES SHALL BE CLEARLY NOTED AND EXPLAINED. SUBMITTAL REVIEW AND ACCEPTANCE IS FOR DESIGN CONCEPT ONLY, AND DOES NOT AT ANY TIME RELIEVE THE CONTRACTOR OF RESPONSIBILITY TO MEET SPECIFICATIONS, CAPACITIES, OR DESIGN INTENT.

G-8 ALL PLUMBING SHALL BE INSTALLED AND CONFORM TO THE 2003 EDITION OF THE IPC WITH UTAH ANNOTATIONS.

G-9 ALL REMOVED ITEMS, PIPING ETC. SHALL BELONG TO THE CONTRACTOR FOR HIS DISPOSAL.

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WATER SUPPLY
NETWORK REPLACEMENT**

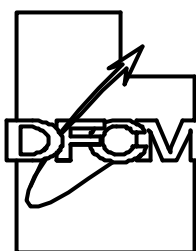DFCM# 04208500

SALT LAKE CITY, UTAH

MARK	DATE	REVISION

PROJECT MANAGER:

SLW

DRAWN BY:

STAFF

CHECKED BY:

SLW/WP


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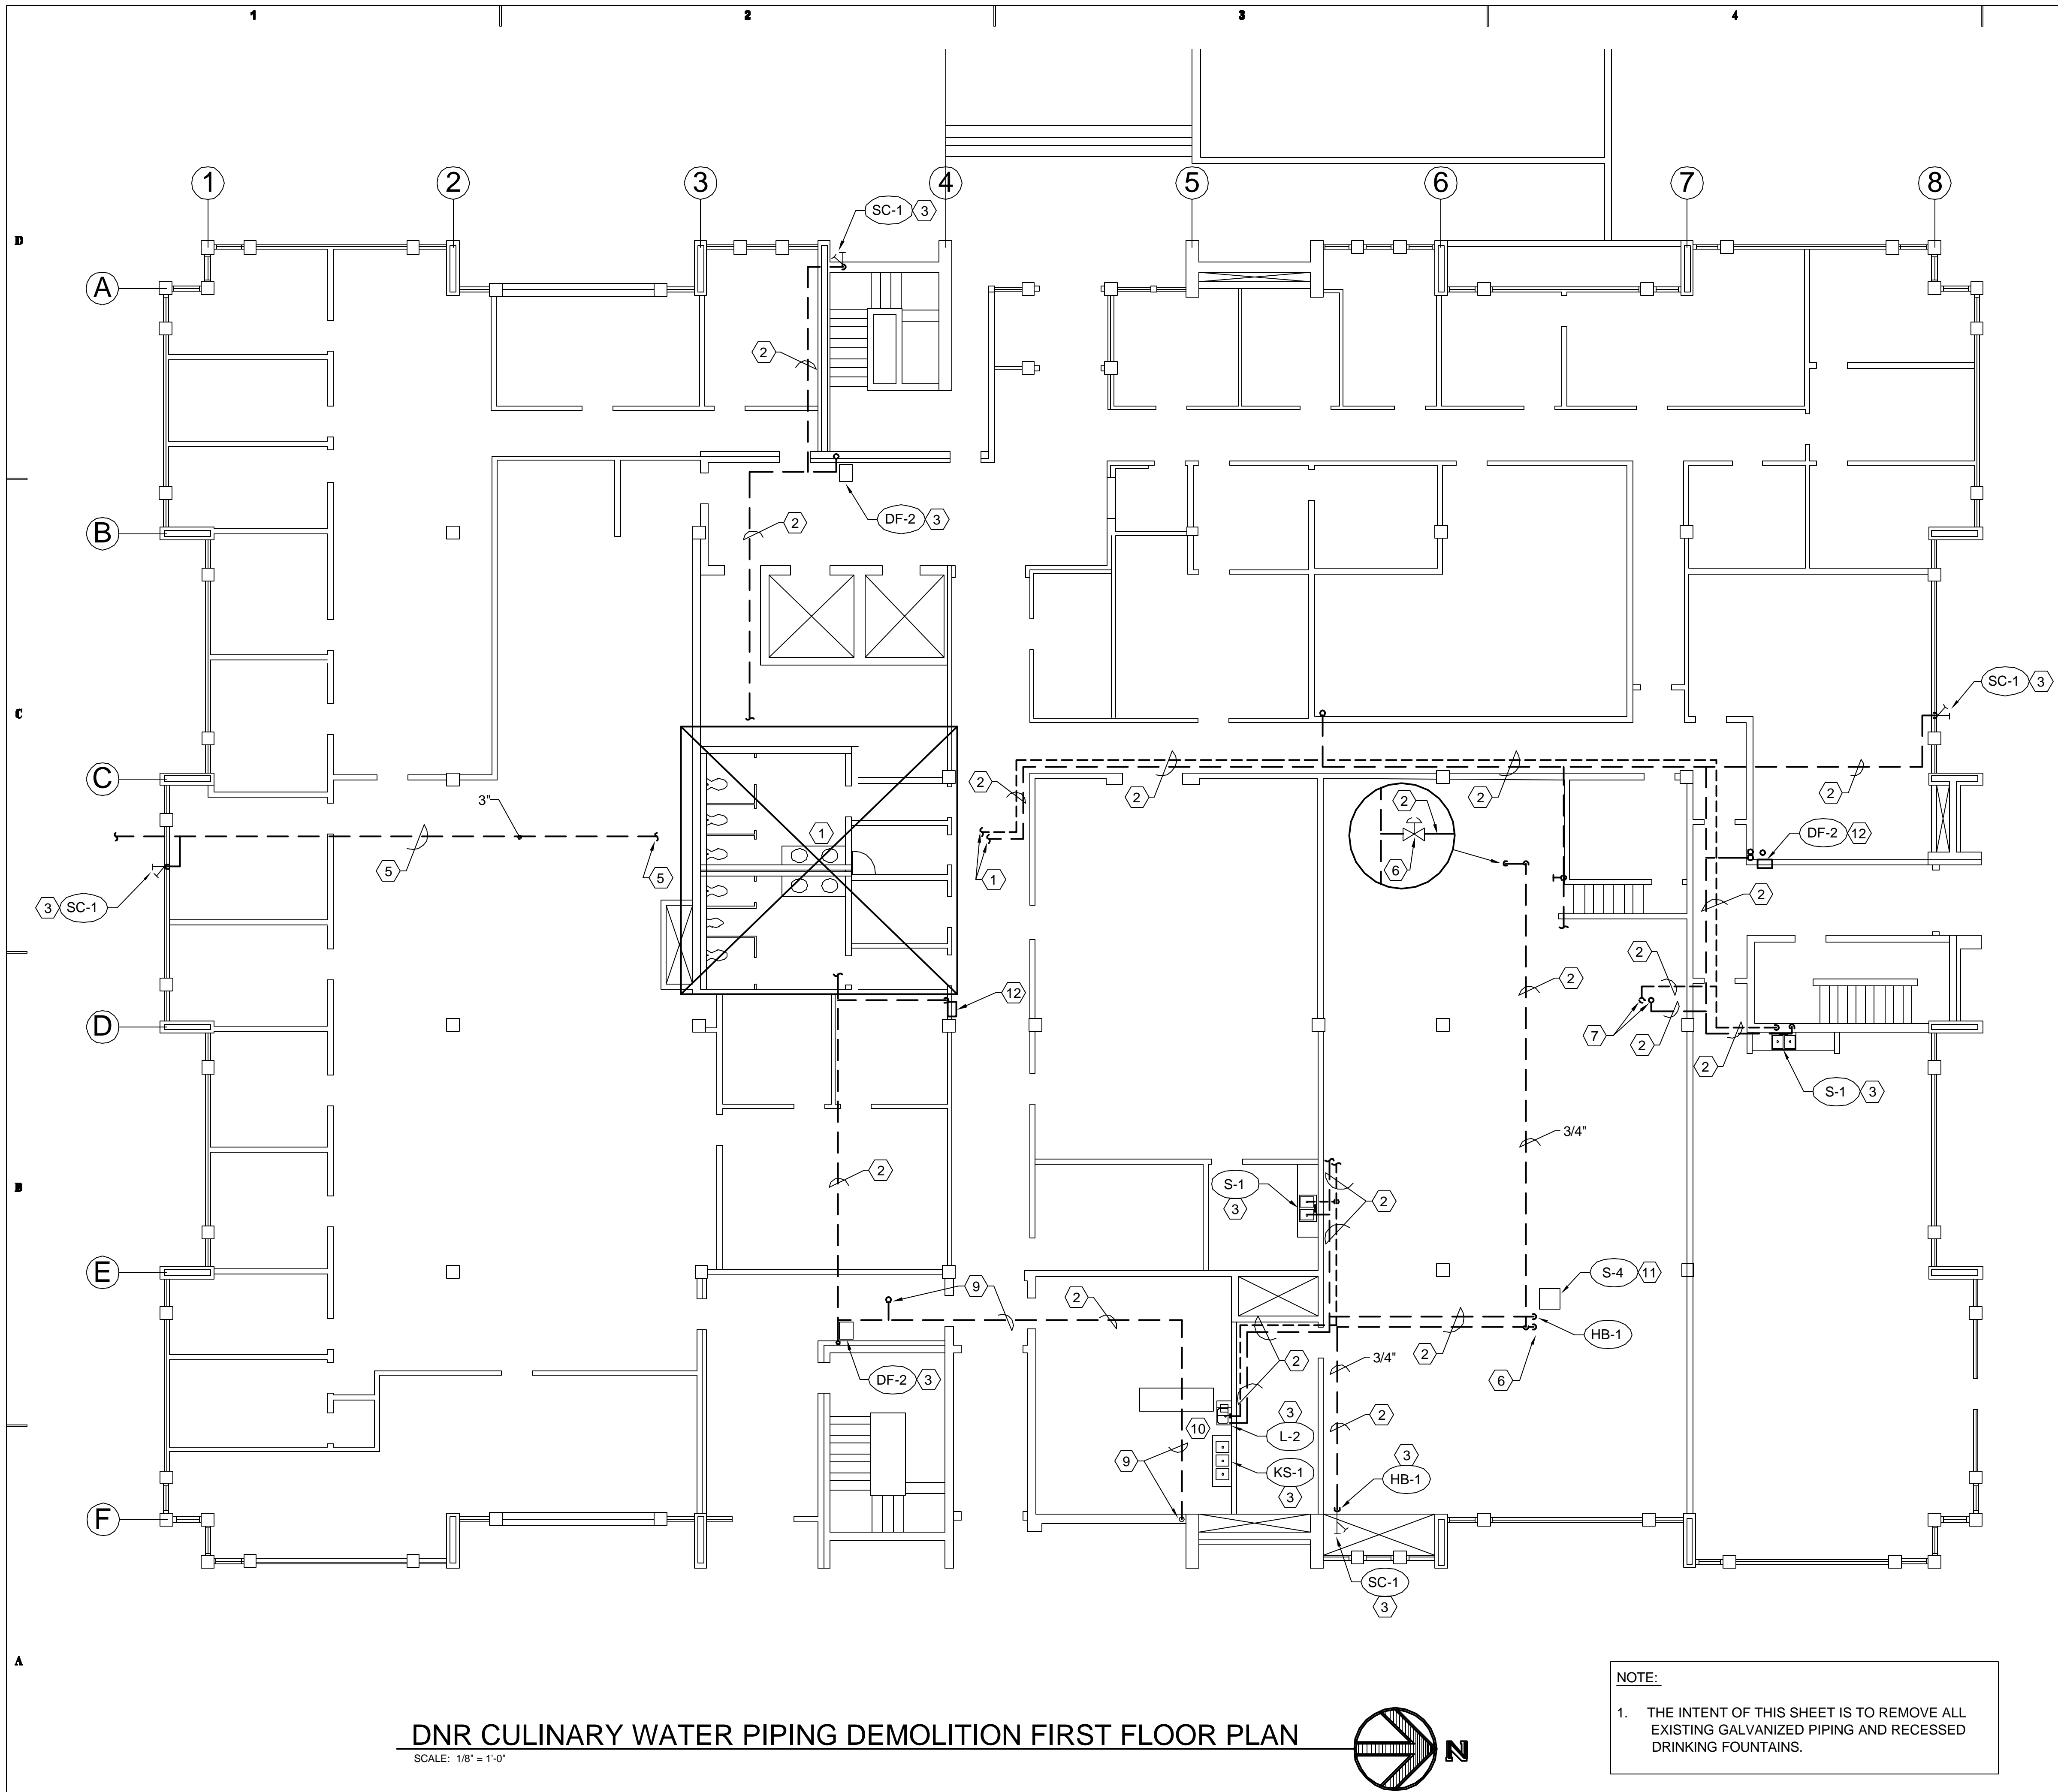
SHEET TITLE



PLUMBING GENERAL
NOTES & LEGEND

SHEET NO.

P001

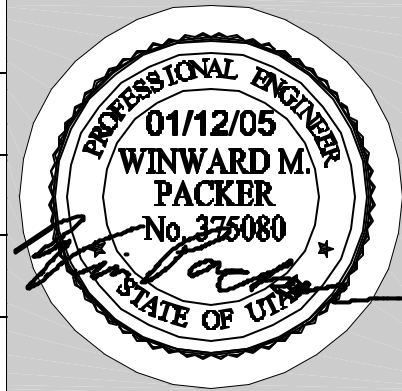

DNR CULINARY WATER PIPING DEMOLITION FIRST FLOOR PLAN

SCALE: 1/8" = 1'-0"

NOTE:

1. THE INTENT OF THIS SHEET IS TO REMOVE ALL EXISTING GALVANIZED PIPING AND RECESSED DRINKING FOUNTAINS.

SHEET NOTES

- 1 SEE C1/PD501 FOR LARGE SCALE REST ROOM PIPING DEMOLITION PLAN.
- 2 REMOVE ALL EXISTING GALVANIZED CULINARY HOT AND COLD WATER PIPING IN OPEN SPACES, ABOVE CEILING AND WHERE ACCESSIBLE. EXISTING PIPING IN WALLS SHALL BE REMOVED IF WALL REPLACEMENT IS NOT REQUIRED. FIELD VERIFY.
- 3 EXISTING PLUMBING FIXTURES SHALL REMAIN. HOT AND COLD WATER TO FIXTURES SHALL BE REMOVED.
- 4 RE-USE AS MANY EXISTING HOLES, OPENINGS, ETC. THRU FLOOR WALLS ETC. FOR INSTALLATION OF NEW COPPER PIPING.
- 5 EXISTING 3" DUCTILE IRON WATER SERVICE PIPING UNDER FLOOR SHALL REMAIN. SEE DETAIL A1/PD501 FOR CONTINUATION.
- 6 REMOVE AND REPLACE ALL AUTO VALVES. ONE PRESSURE REDUCING STATION, AND BACK FLOW PREVENTORS IN BOILER AND CHILLER ROOM.
- 7 REMOVE HOT AND COLD WATER PIPING TO SECOND FLOOR. SEE SHEET PD102 FOR CONTINUATION.
- 8 CONTRACTOR SHALL VERIFY ALL PIPING LOCATIONS.
- 9 SINCE SILCOCK WAS SHOWN ON THE RECORD DRAWINGS AS WELL AS THE DRINKING FOUNTAINS ON THE SECOND AND THIRD FLOOR, BUT ARE NOT INSTALLED, CONTRACTOR SHALL VERIFY IF THIS PIPING EXISTS. IF PIPING IS INSTALLED, IT SHALL BE REMOVED BUT NOT REPLACED.
- 10 EXISTING PIPING TO KITCHEN IF COPPER SHALL REMAIN. IF PIPING IS GALVANIZED, SOFT COPPER OR TYPE M, IT SHALL BE REMOVED.
- 11 EXISTING SINK S-4 IN BOILER AND CHILLER ROOM SHALL REMAIN. HOT AND COLD WATER SHALL BE REMOVED.
- 12 EXISTING DF-1 SHALL BE REMOVED ALONG WITH PIPING.

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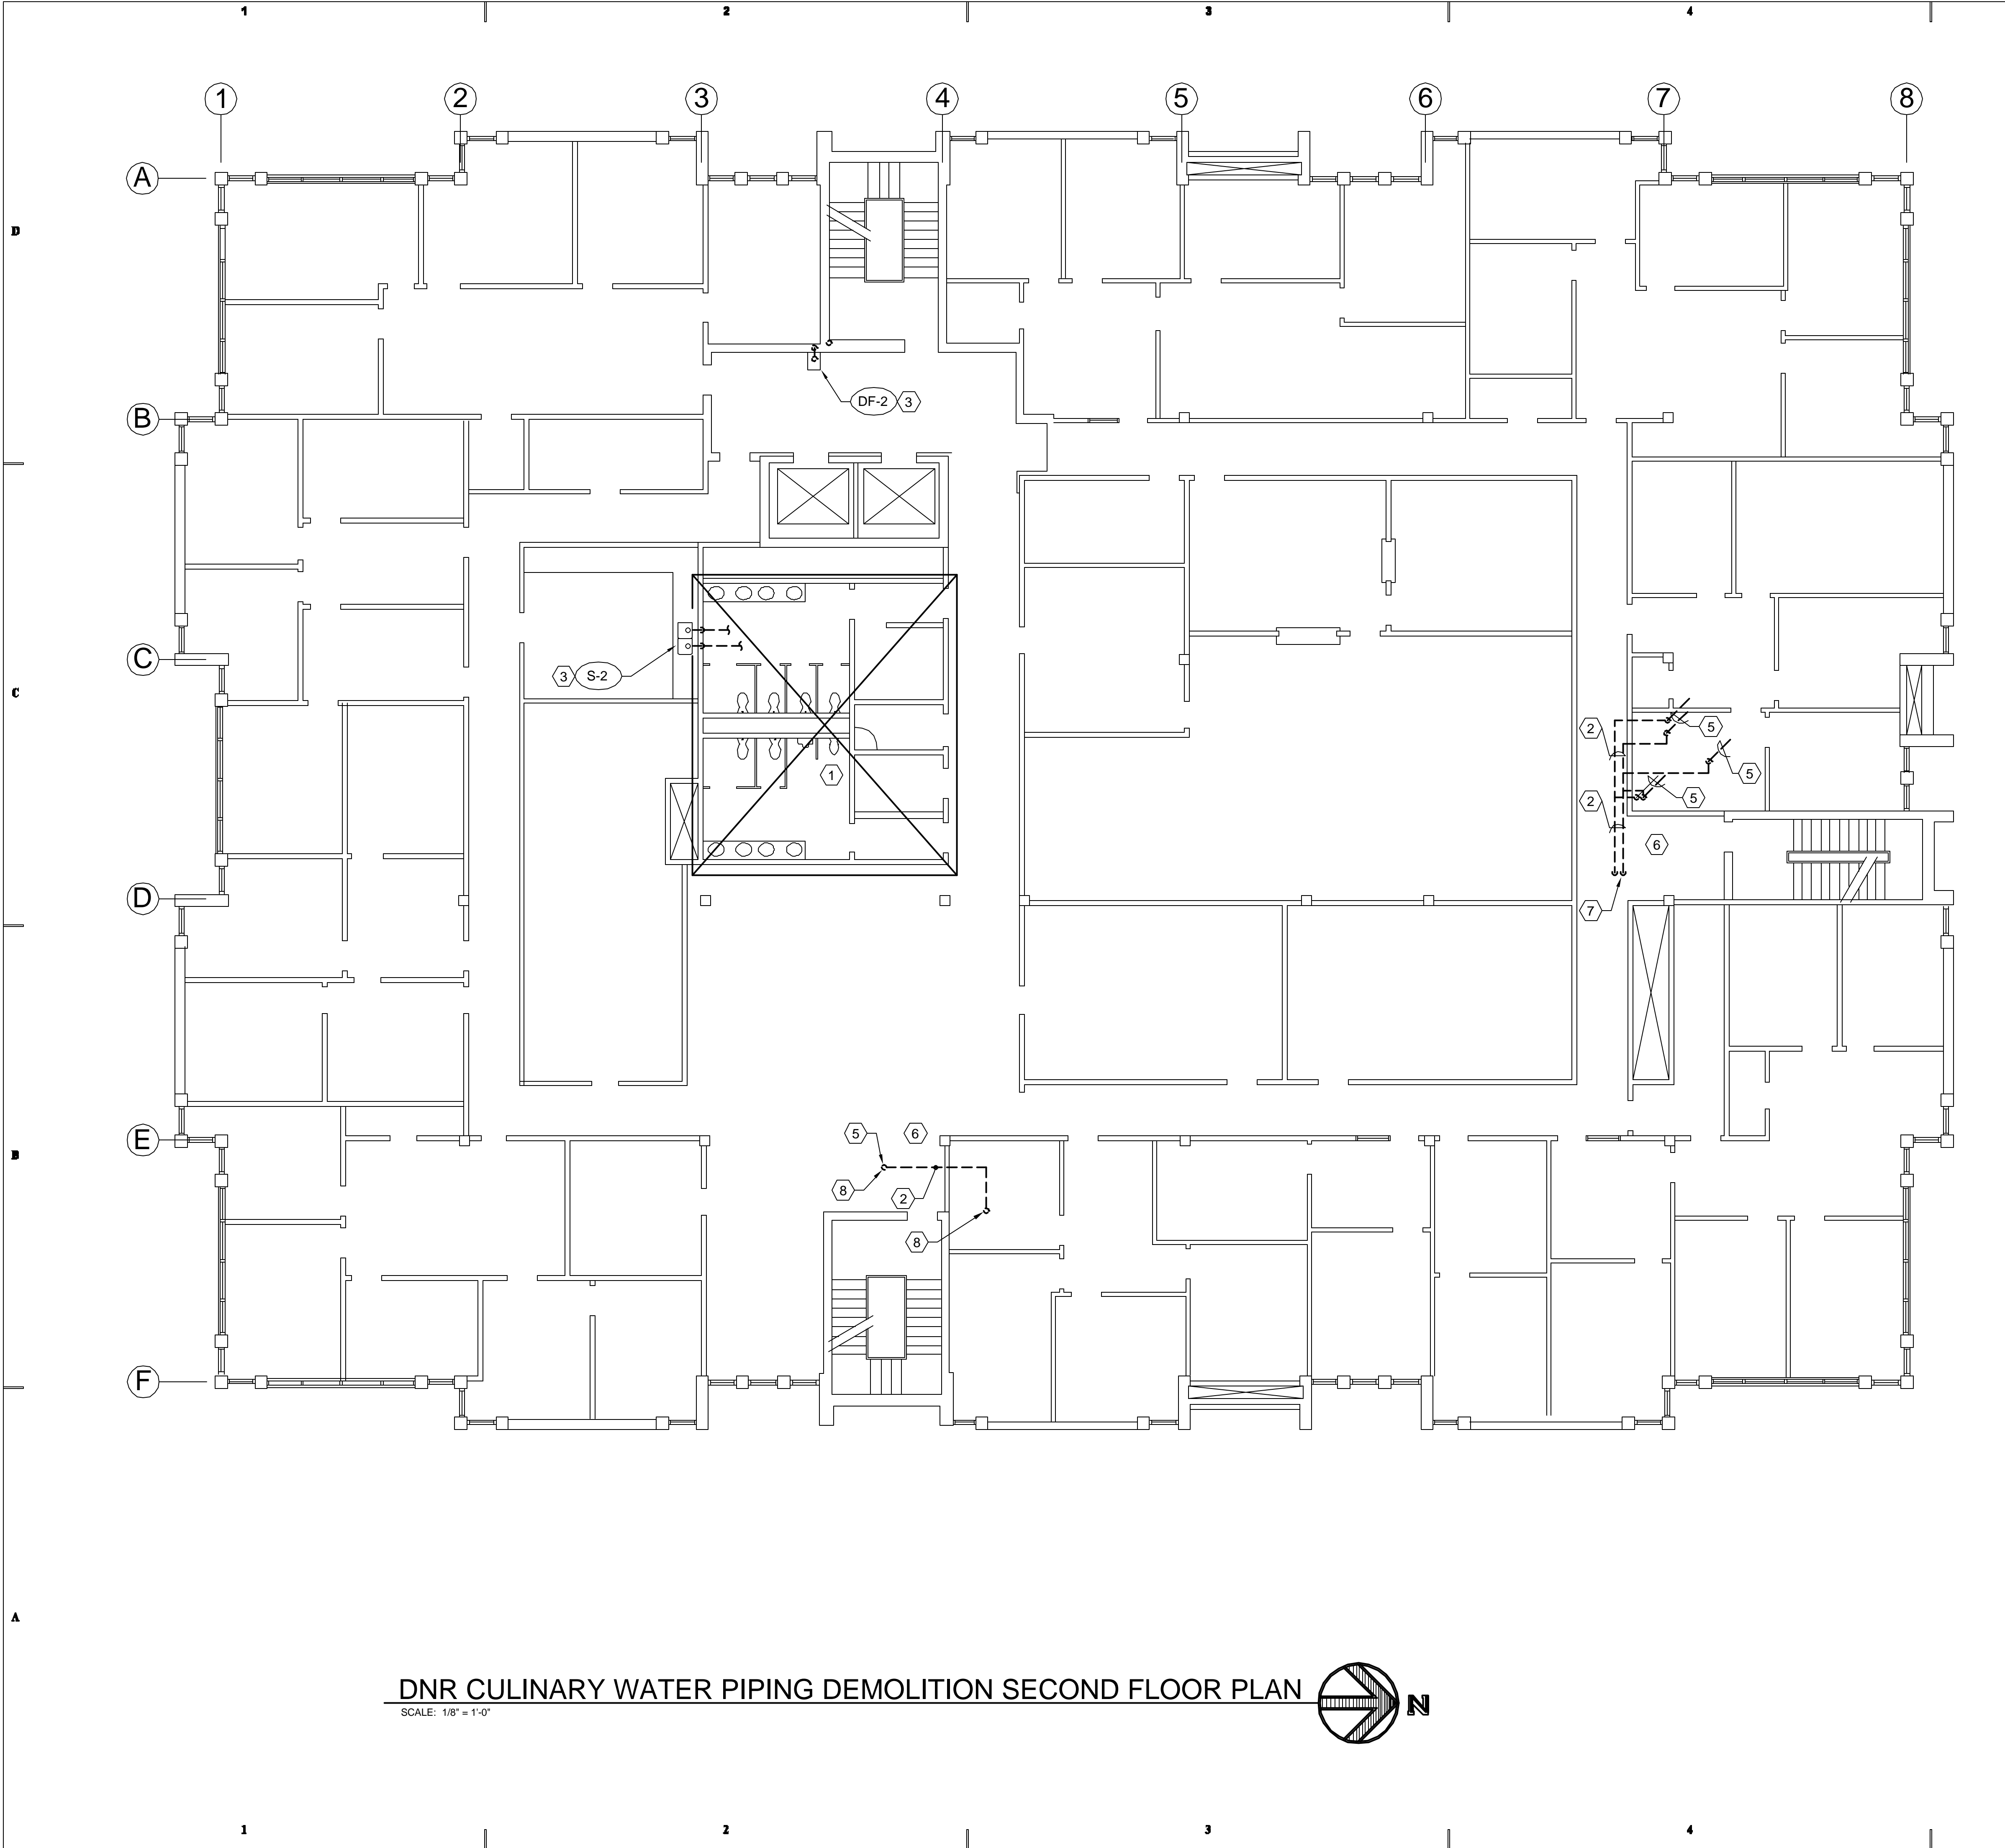
SHEET TITLE

FIRST FLOOR
CULINARY WATER PIPING
DEMOLITION PLAN

SHEET NO.

PD101





SHEET NOTES

- 1 SEE A1/PD201 FOR LARGE SCALE RESTROOM PIPING DEMOLITION PLAN.
- 2 REMOVE ALL EXISTING GALVANIZED CULINARY HOT AND COLD WATER PIPING IN OPEN SPACES, ABOVE CEILINGS, UNDERFLOOR AND WHERE ACCESSABLE. PIPING IN WALLS SHALL BE REMOVED IF WALL REPLACEMENT IS NOT REQUIRED. FIELD VERIFY.
- 3 EXISTING PLUMBING FIXTURES SHALL REMAIN, BUT HOT AND COLD WATER TO FIXTURES SHALL BE REMOVED.
- 4 RE-USE AS MANY EXISTING HOLES, OPENINGS, ETC. THRU FLOORS, CEILINGS, WALLS, ETC. FOR INSTALLATION OF NEW COPPER PIPING.
- 5 REMOVE HOT OR COLD PIPING TO 3RD FLOOR. SEE SHEET PD103 FOR CONTINUATION.
- 6 CONTRACTOR SHALL FIELD VERIFY ALL PIPING LOCATIONS.
- 7 HOT AND COLD WATER RISERS FROM 1ST FLOOR. SEE SHEET PD101 FOR SOURCE.
- 8 FIELD VERIFY THAT PIPING TO REMOVED DRINKING FOUNTAINS ON THE 2ND AND 3RD FLOORS IS STILL INSTALLED. IF PIPING IS STILL IN PLACE, REMOVE BUT DO NOT REPLACE.

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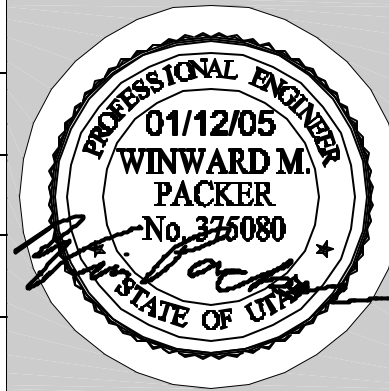
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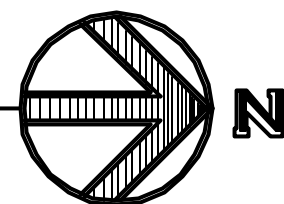
SECOND FLOOR
CULINARY WATER PIPING
DEMOLITION PLAN


SHEET NO.

PD102

DNR CULINARY WATER PIPING DEMOLITION SECOND FLOOR PLAN

SCALE: 1/8" = 1'-0"



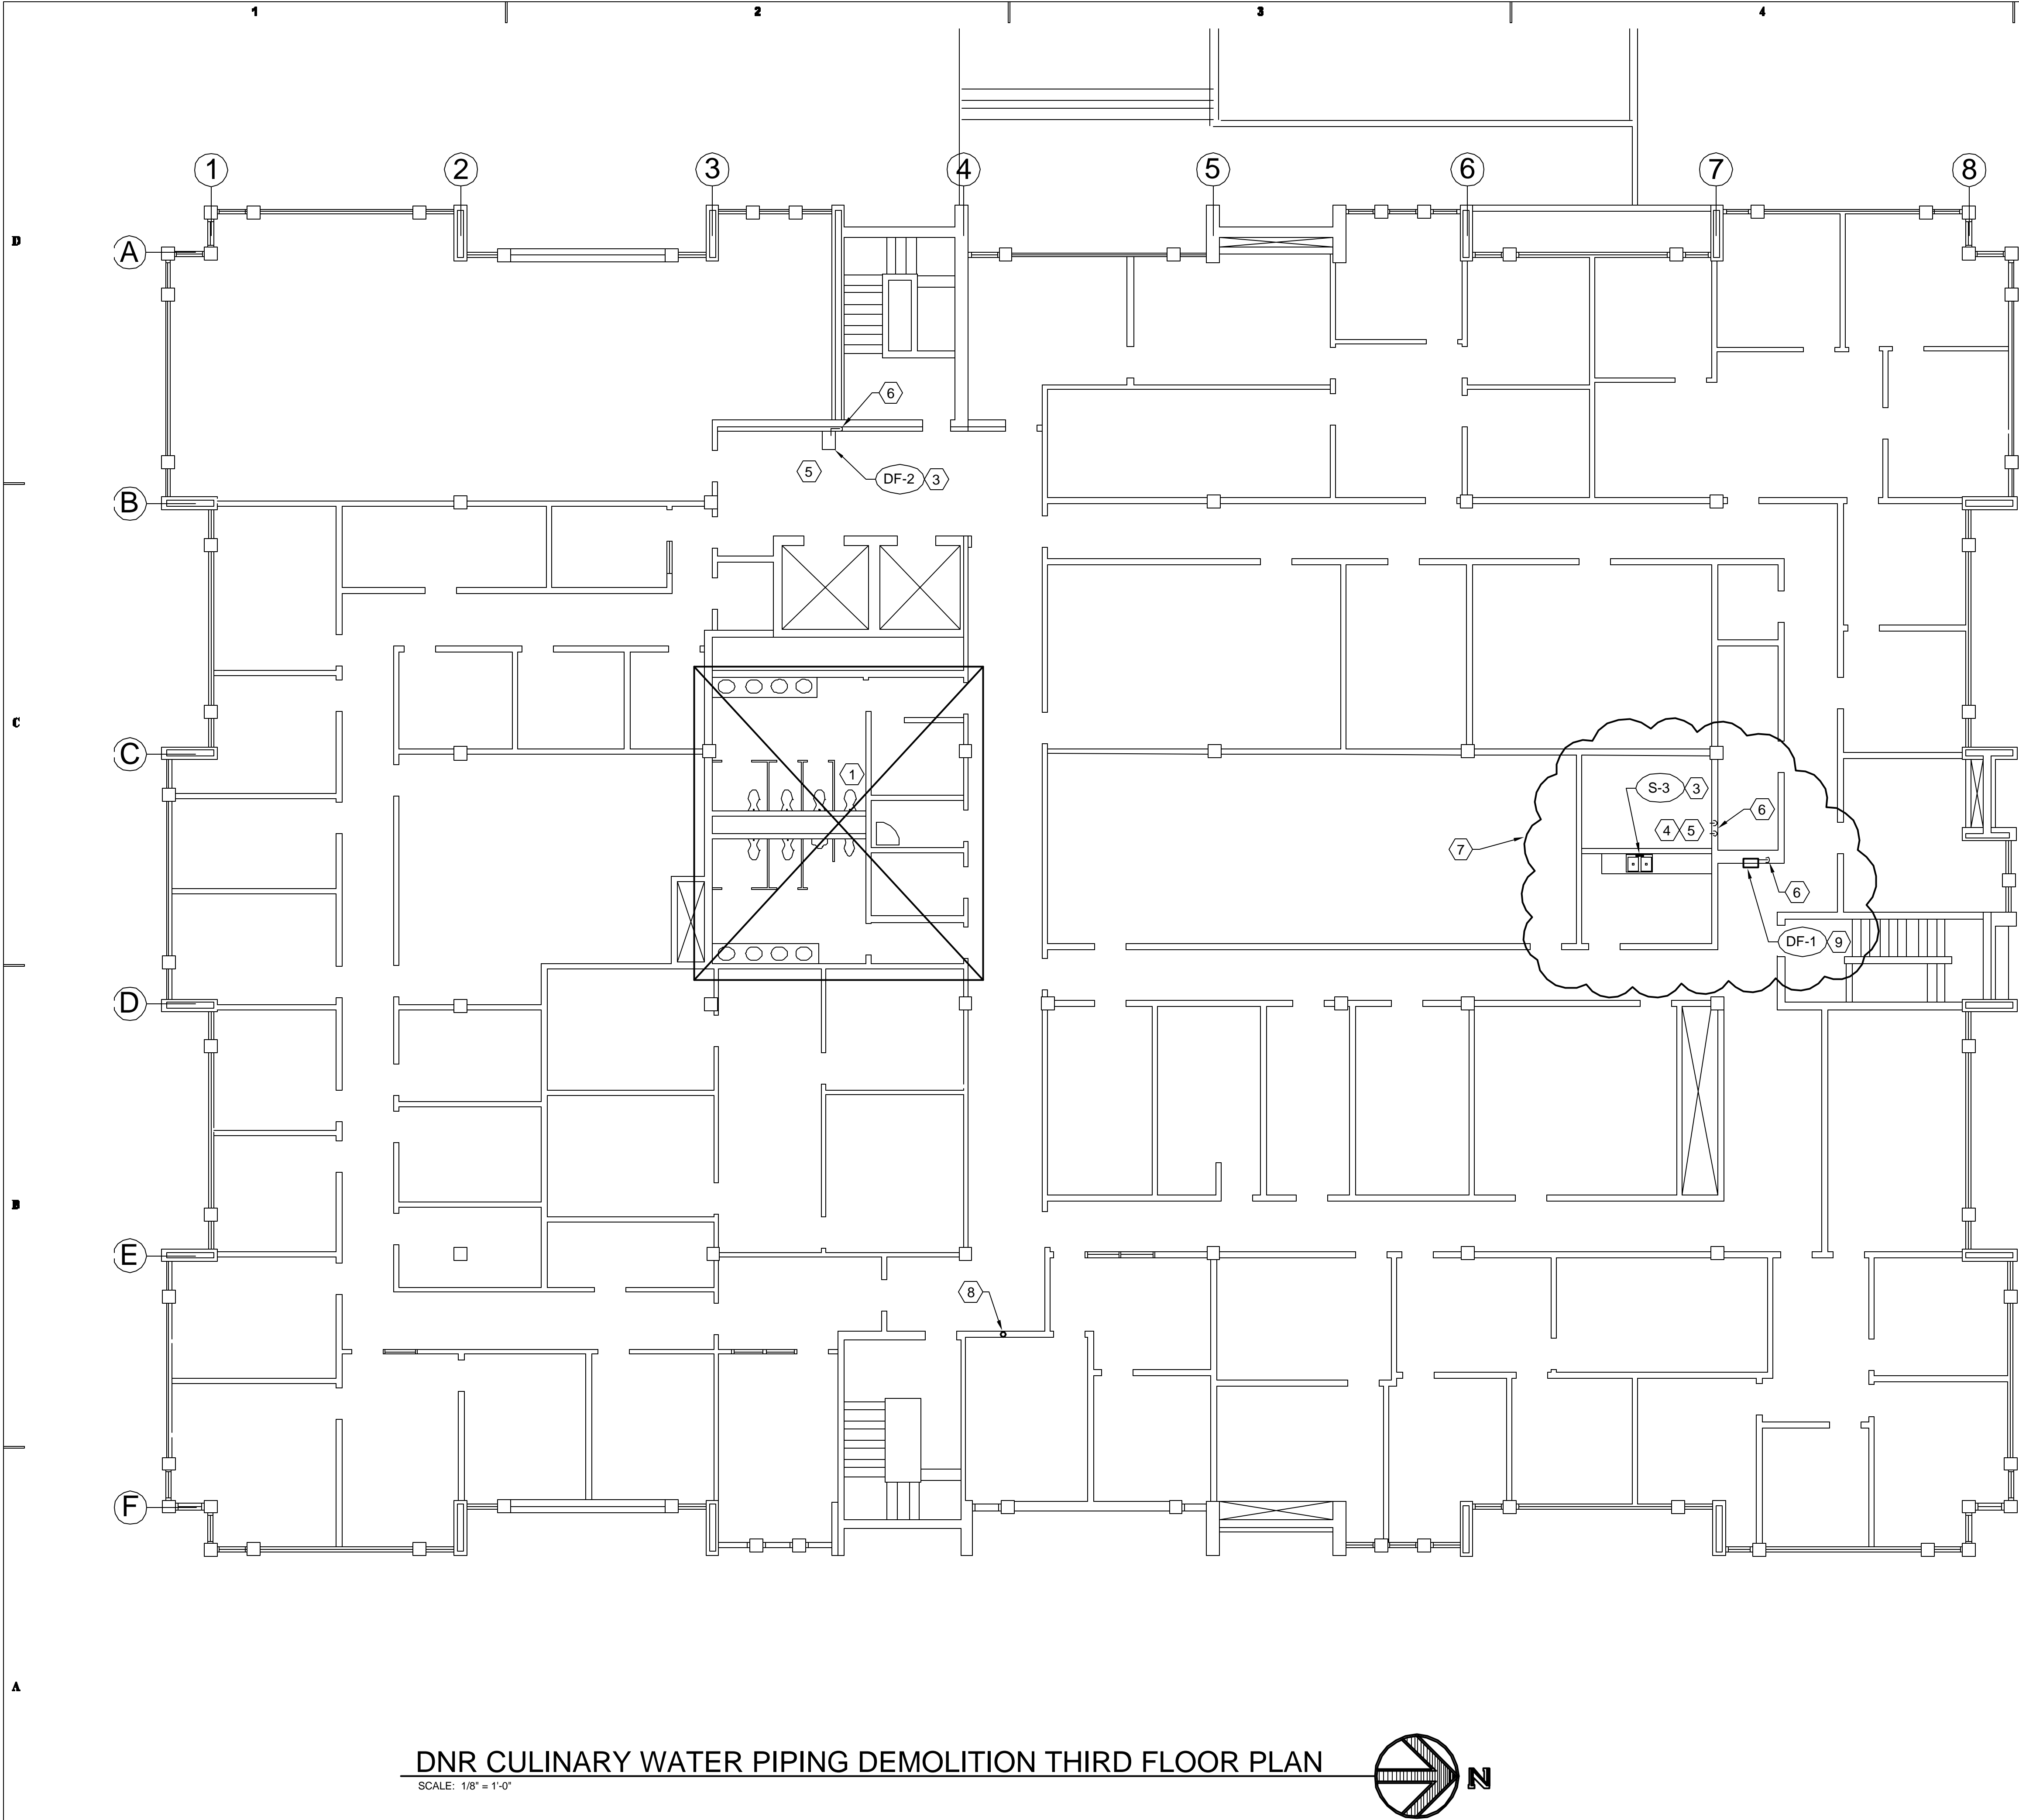

DNR CULINARY WATER PIPING DEMOLITION THIRD FLOOR PLAN

SCALE: 1/8" = 1'-0"

SHEET NOTES

- SEE A3/PD201 FOR LARGE SCALE RESTROOM PIPING DEMOLITION PLAN.
- REMOVE ALL EXISTING GALVANIZED CULINARY HOT AND COLD WATER PIPING IN OPEN SPACES, BELOW FLOOR, AND WHERE ACCESSABLE. PIPING IN WALLS SHALL BE REMOVED IF WALL REPLACEMENT IS NOT REQUIRED. FIELD VERIFY.
- EXISTING PLUMBING FIXTURES SHALL REMAIN, BUT HOT AND COLD WATER TO FIXTURES SHALL BE REMOVED.
- RE-USE AS MANY EXISTING HOLES, OPENINGS, ETC. THRU FLOORS, WALLS, ETC. FOR INSTALLATION OF NEW COPPER PIPING.
- CONTRACTOR SHALL FIELD VERIFY ALL PIPING LOCATIONS.
- HOT AND COLD WATER RISERS FROM 2ND FLOOR. SEE SHEET PD102 FOR SOURCE.
- THIS AREA HAS BEEN CHANGED SINCE THE RECORD DRAWINGS. CONTRACTOR SHALL FIELD VERIFY THE EXISTING PIPING IN THIS AREA AND REMOVE ANY GALVANIZED PIPING.
- REMOVE 1/2"Ø COLD WATER PIPING THAT WAS SERVING REMOVED DRINKING FOUNTAIN. DO NOT REPLACE PIPING. SEE SHEET PD-102 FOR SOURCE.
- REMOVE EXISTING RECESSED DRINKING FOUNTAIN.

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SHEET TITLE

THIRD FLOOR
CULINARY WATER PIPING
DEMOLITION PLAN

SHEET NO.

PD103

SHEET NOTES

- 1 REMOVE ALL EXISTING GALVANIZED CULINARY HOT AND COLD WATER PIPING. CONTRACTOR AND ENGINEER SHALL COORDINATE PIPING IN WALLS. SEE DETAILS A2 AND A4/PD501 FOR SAMPLES.
- 2 EXISTING FIXTURES SHALL REMAIN BUT ALL GALVANIZED PIPING REMOVED.
- 3 REMOVE EXISTING WATER HEADER. COMPLETE WITH VALVES, FITTINGS, PRV ETC. SEE DETAILS C1, C2, C4, AND A1/PD501.
- 4 REMOVE EXISTING WATER HEATER. SEE DETAILS C1, AND C2/PD501.
- 5 SEE SHEET PD101, 102, AND 103, FOR CONTINUATION AND REMOVAL OF EXISTING GALVANIZED PIPING.
- 6 LOCATIONS AND CONFIGURATION OF EXISTING PIPING SHALL BE FIELD VERIFIED BY CONTRACTOR.
- 7 SEE LARGE SCALE OF THIS ROOM PD202 FOR DEMOLITION OF THIS AREA AND SHEET PD501.
- 8 REMOVE EXISTING RECESSED DRINKING FOUNTAIN DF-1.

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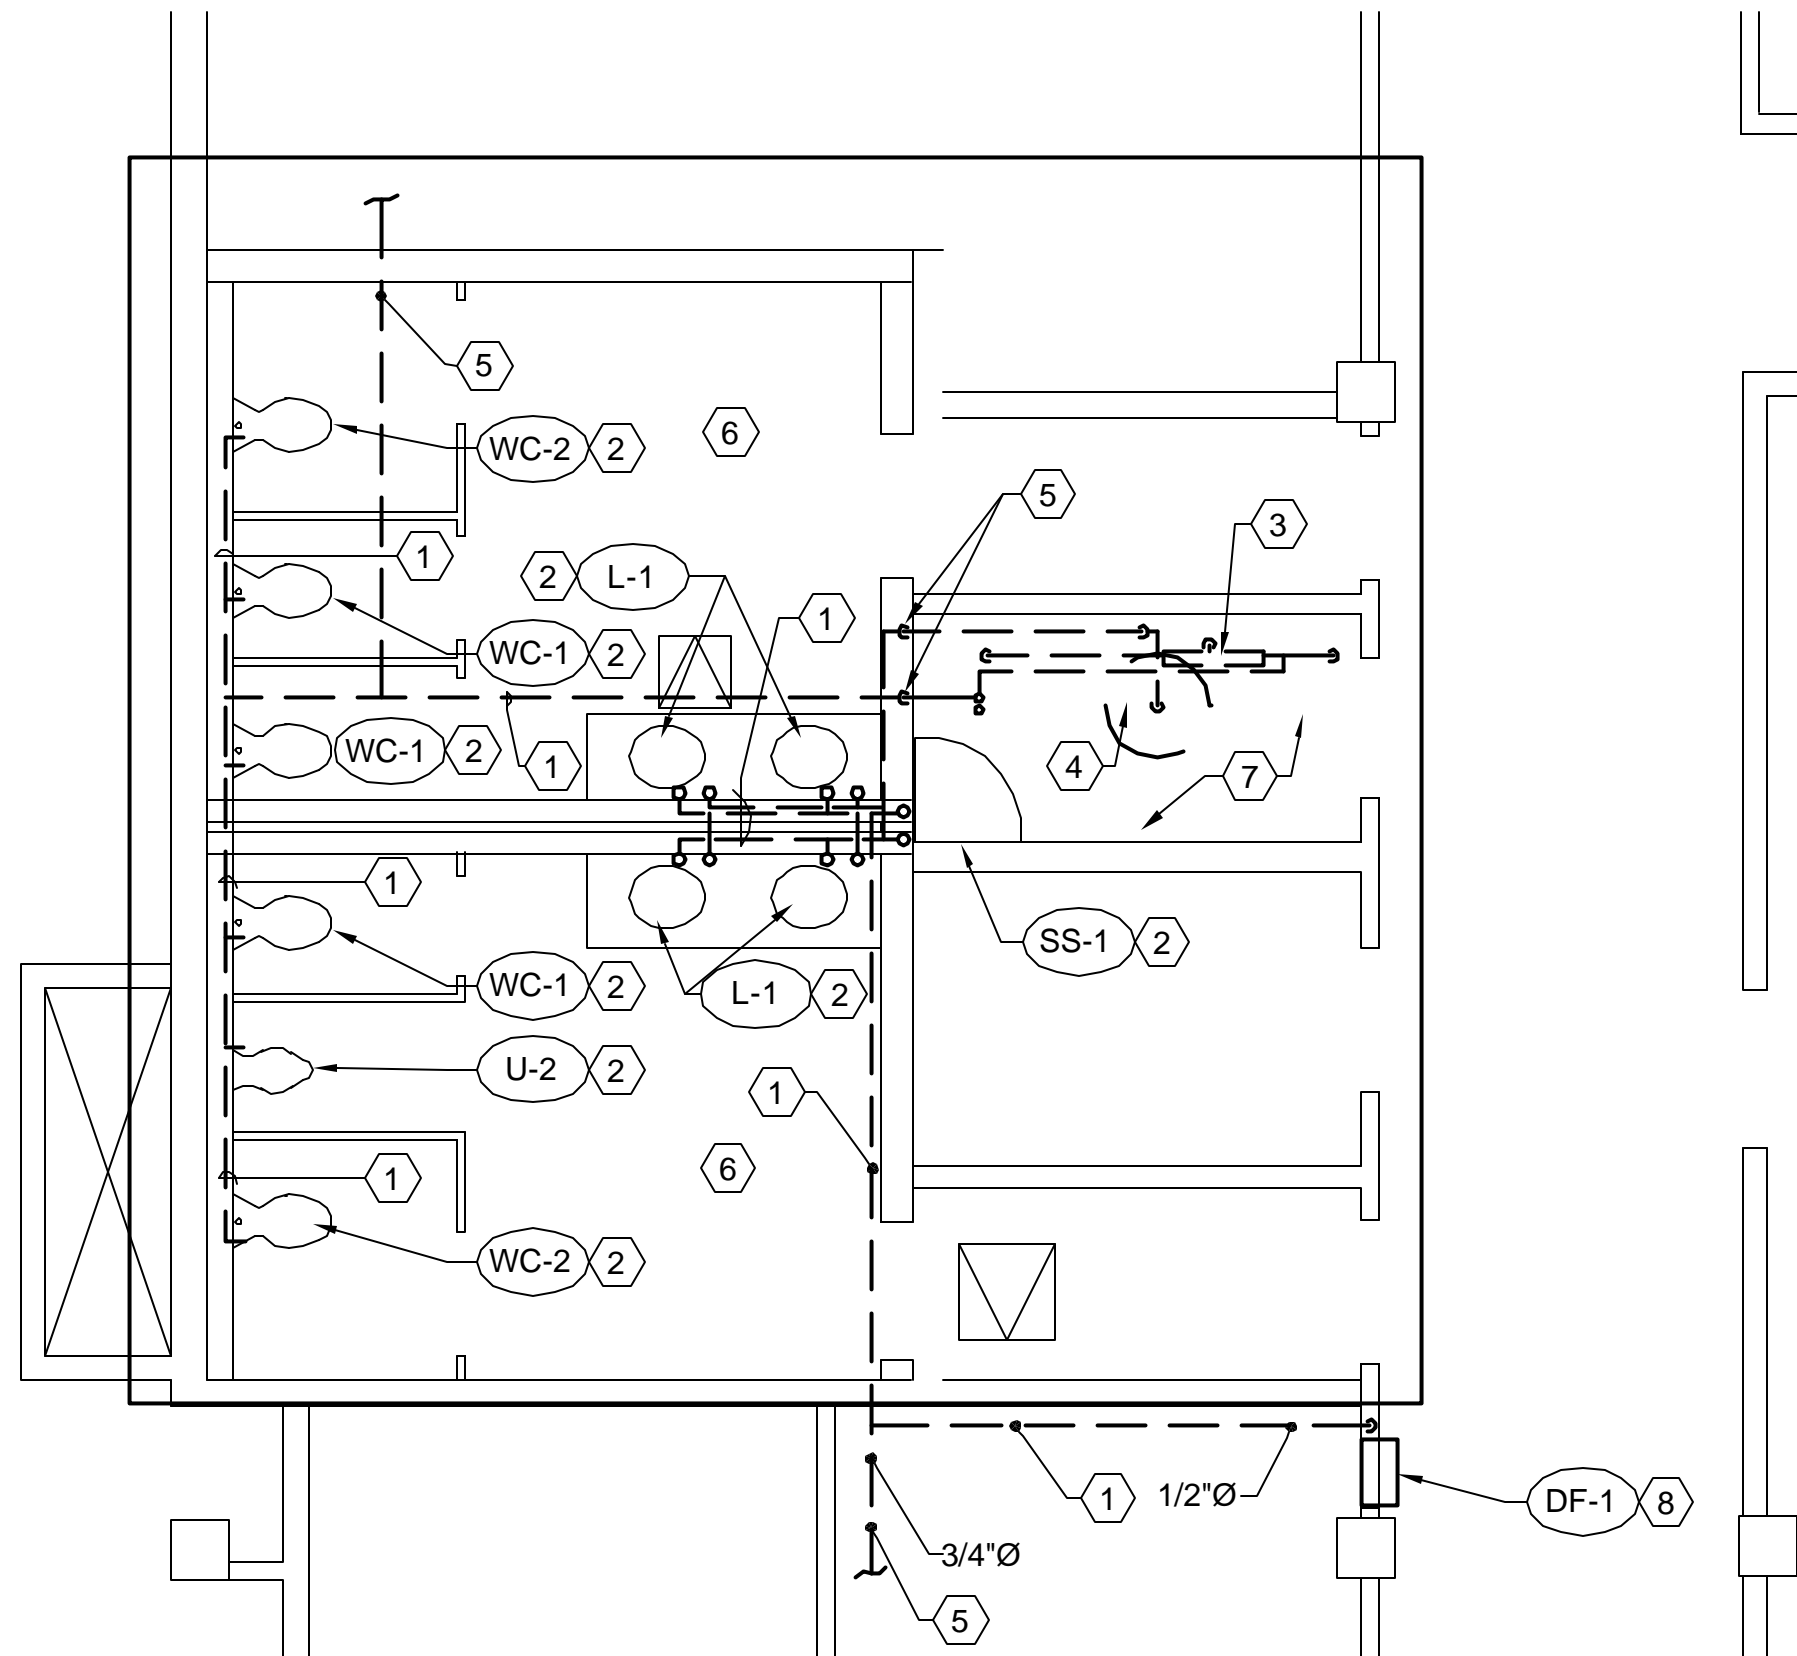
SHEET TITLE



ENLARGED CULINARY
PIPING RESTROOM
DEMOLITION PLANS


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PD201




**DNR ENLARGED FIRST FLOOR
RESTROOM PIPING DEMO. PLAN**

SCALE: 1/4" = 1'-0"

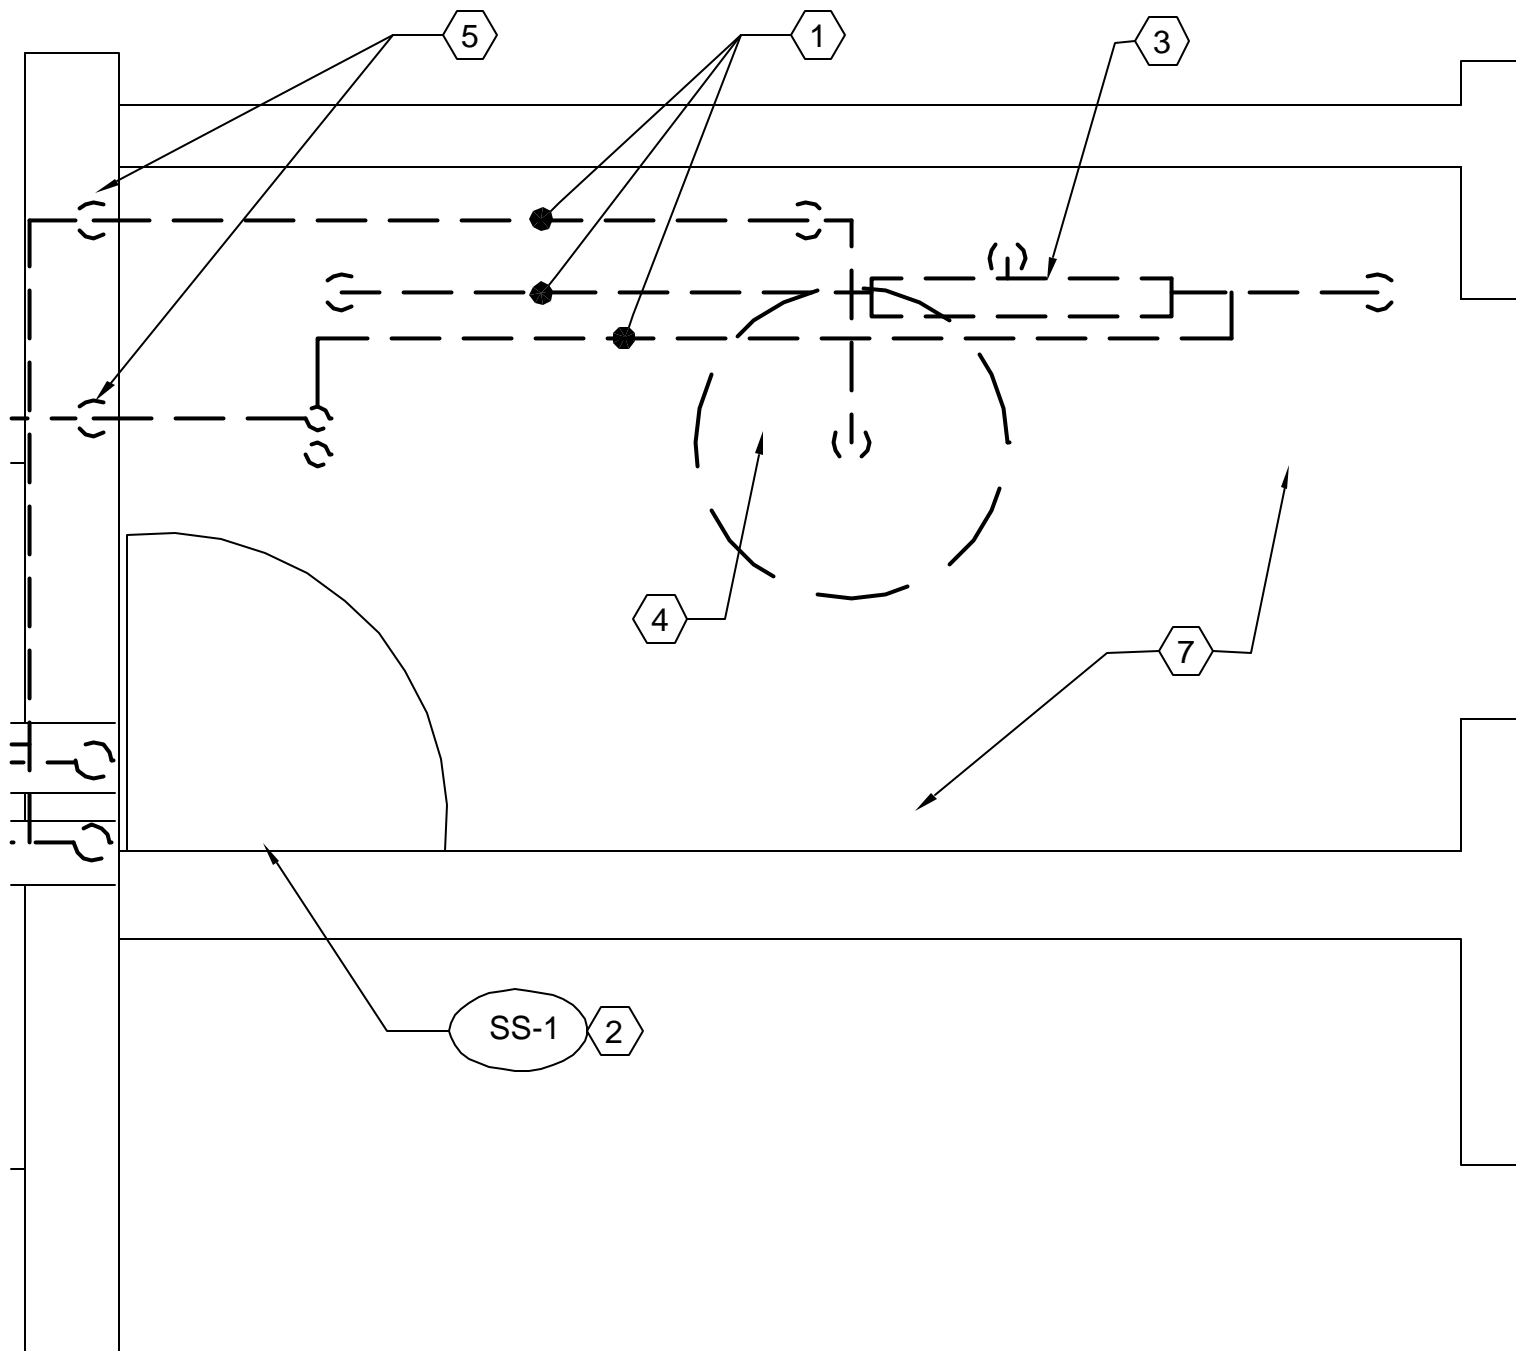


**DNR ENLARGED FIRST FLOOR
JANITORS ROOM PIPING DEMO. PLAN**

SCALE: 3/4" = 1'-0"

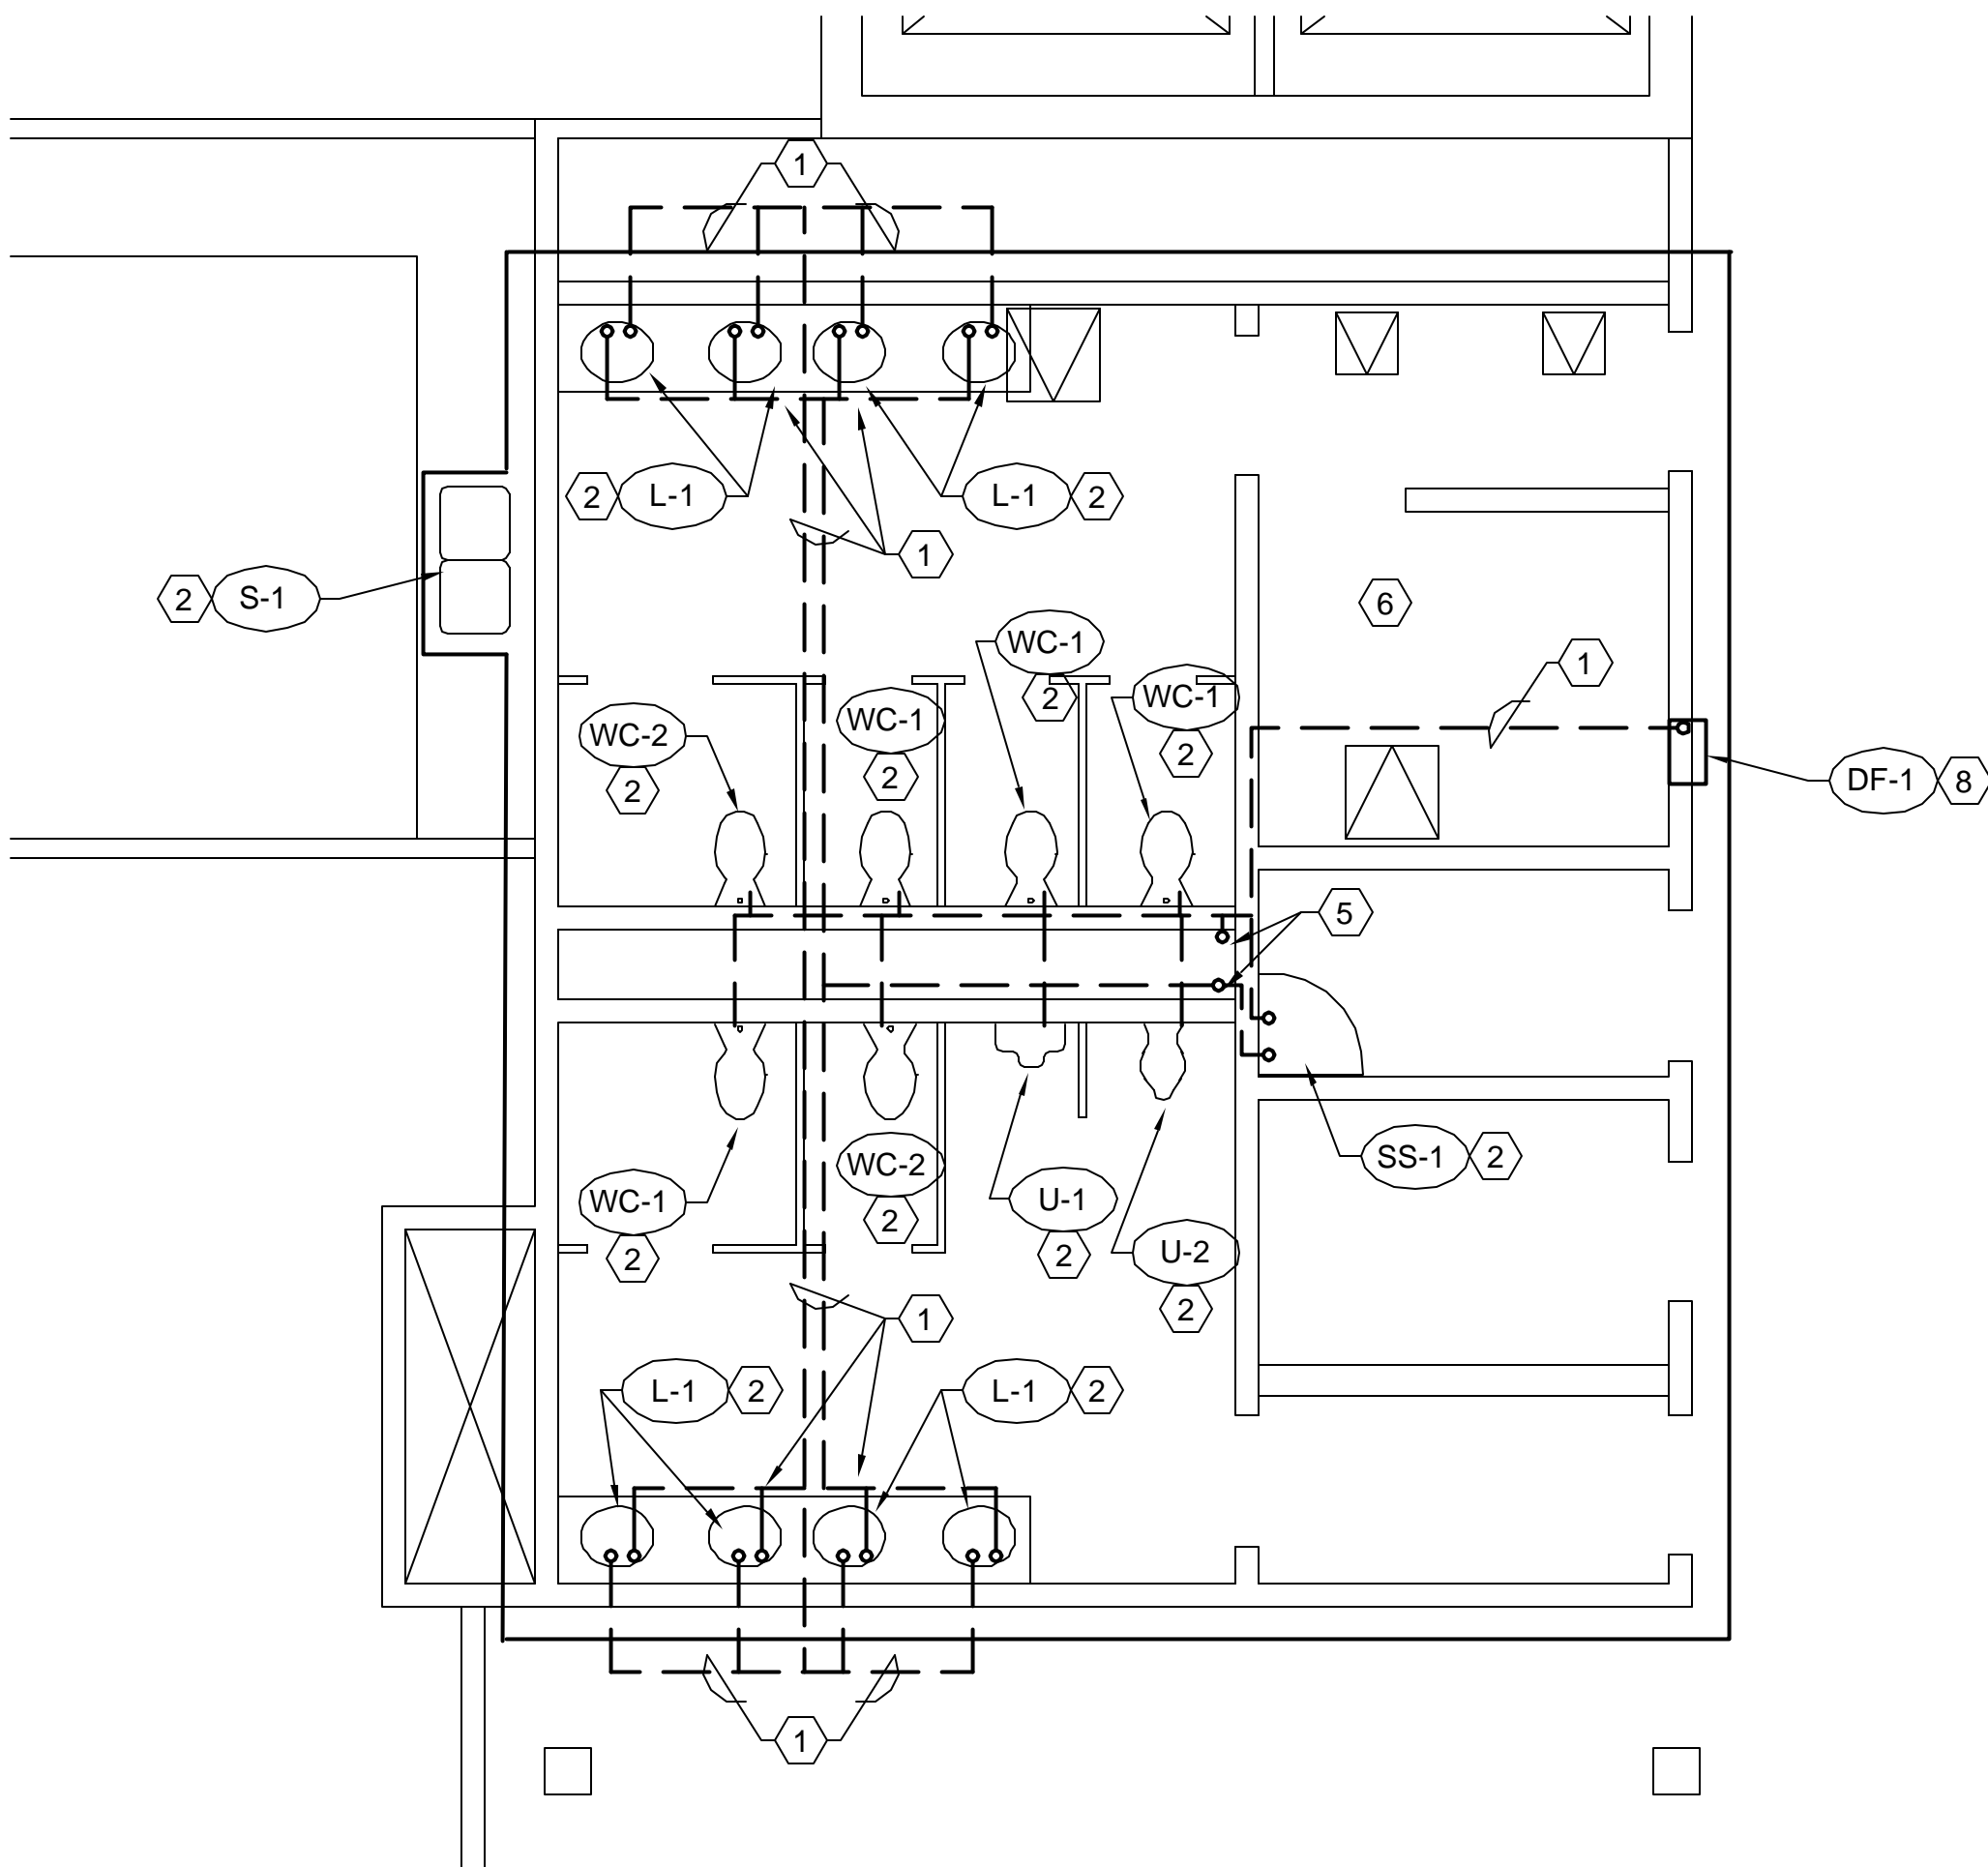

**DNR ENLARGED SECOND FLOOR
RESTROOM PIPING DEMO. PLAN**

SCALE: 1/4" = 1'-0"

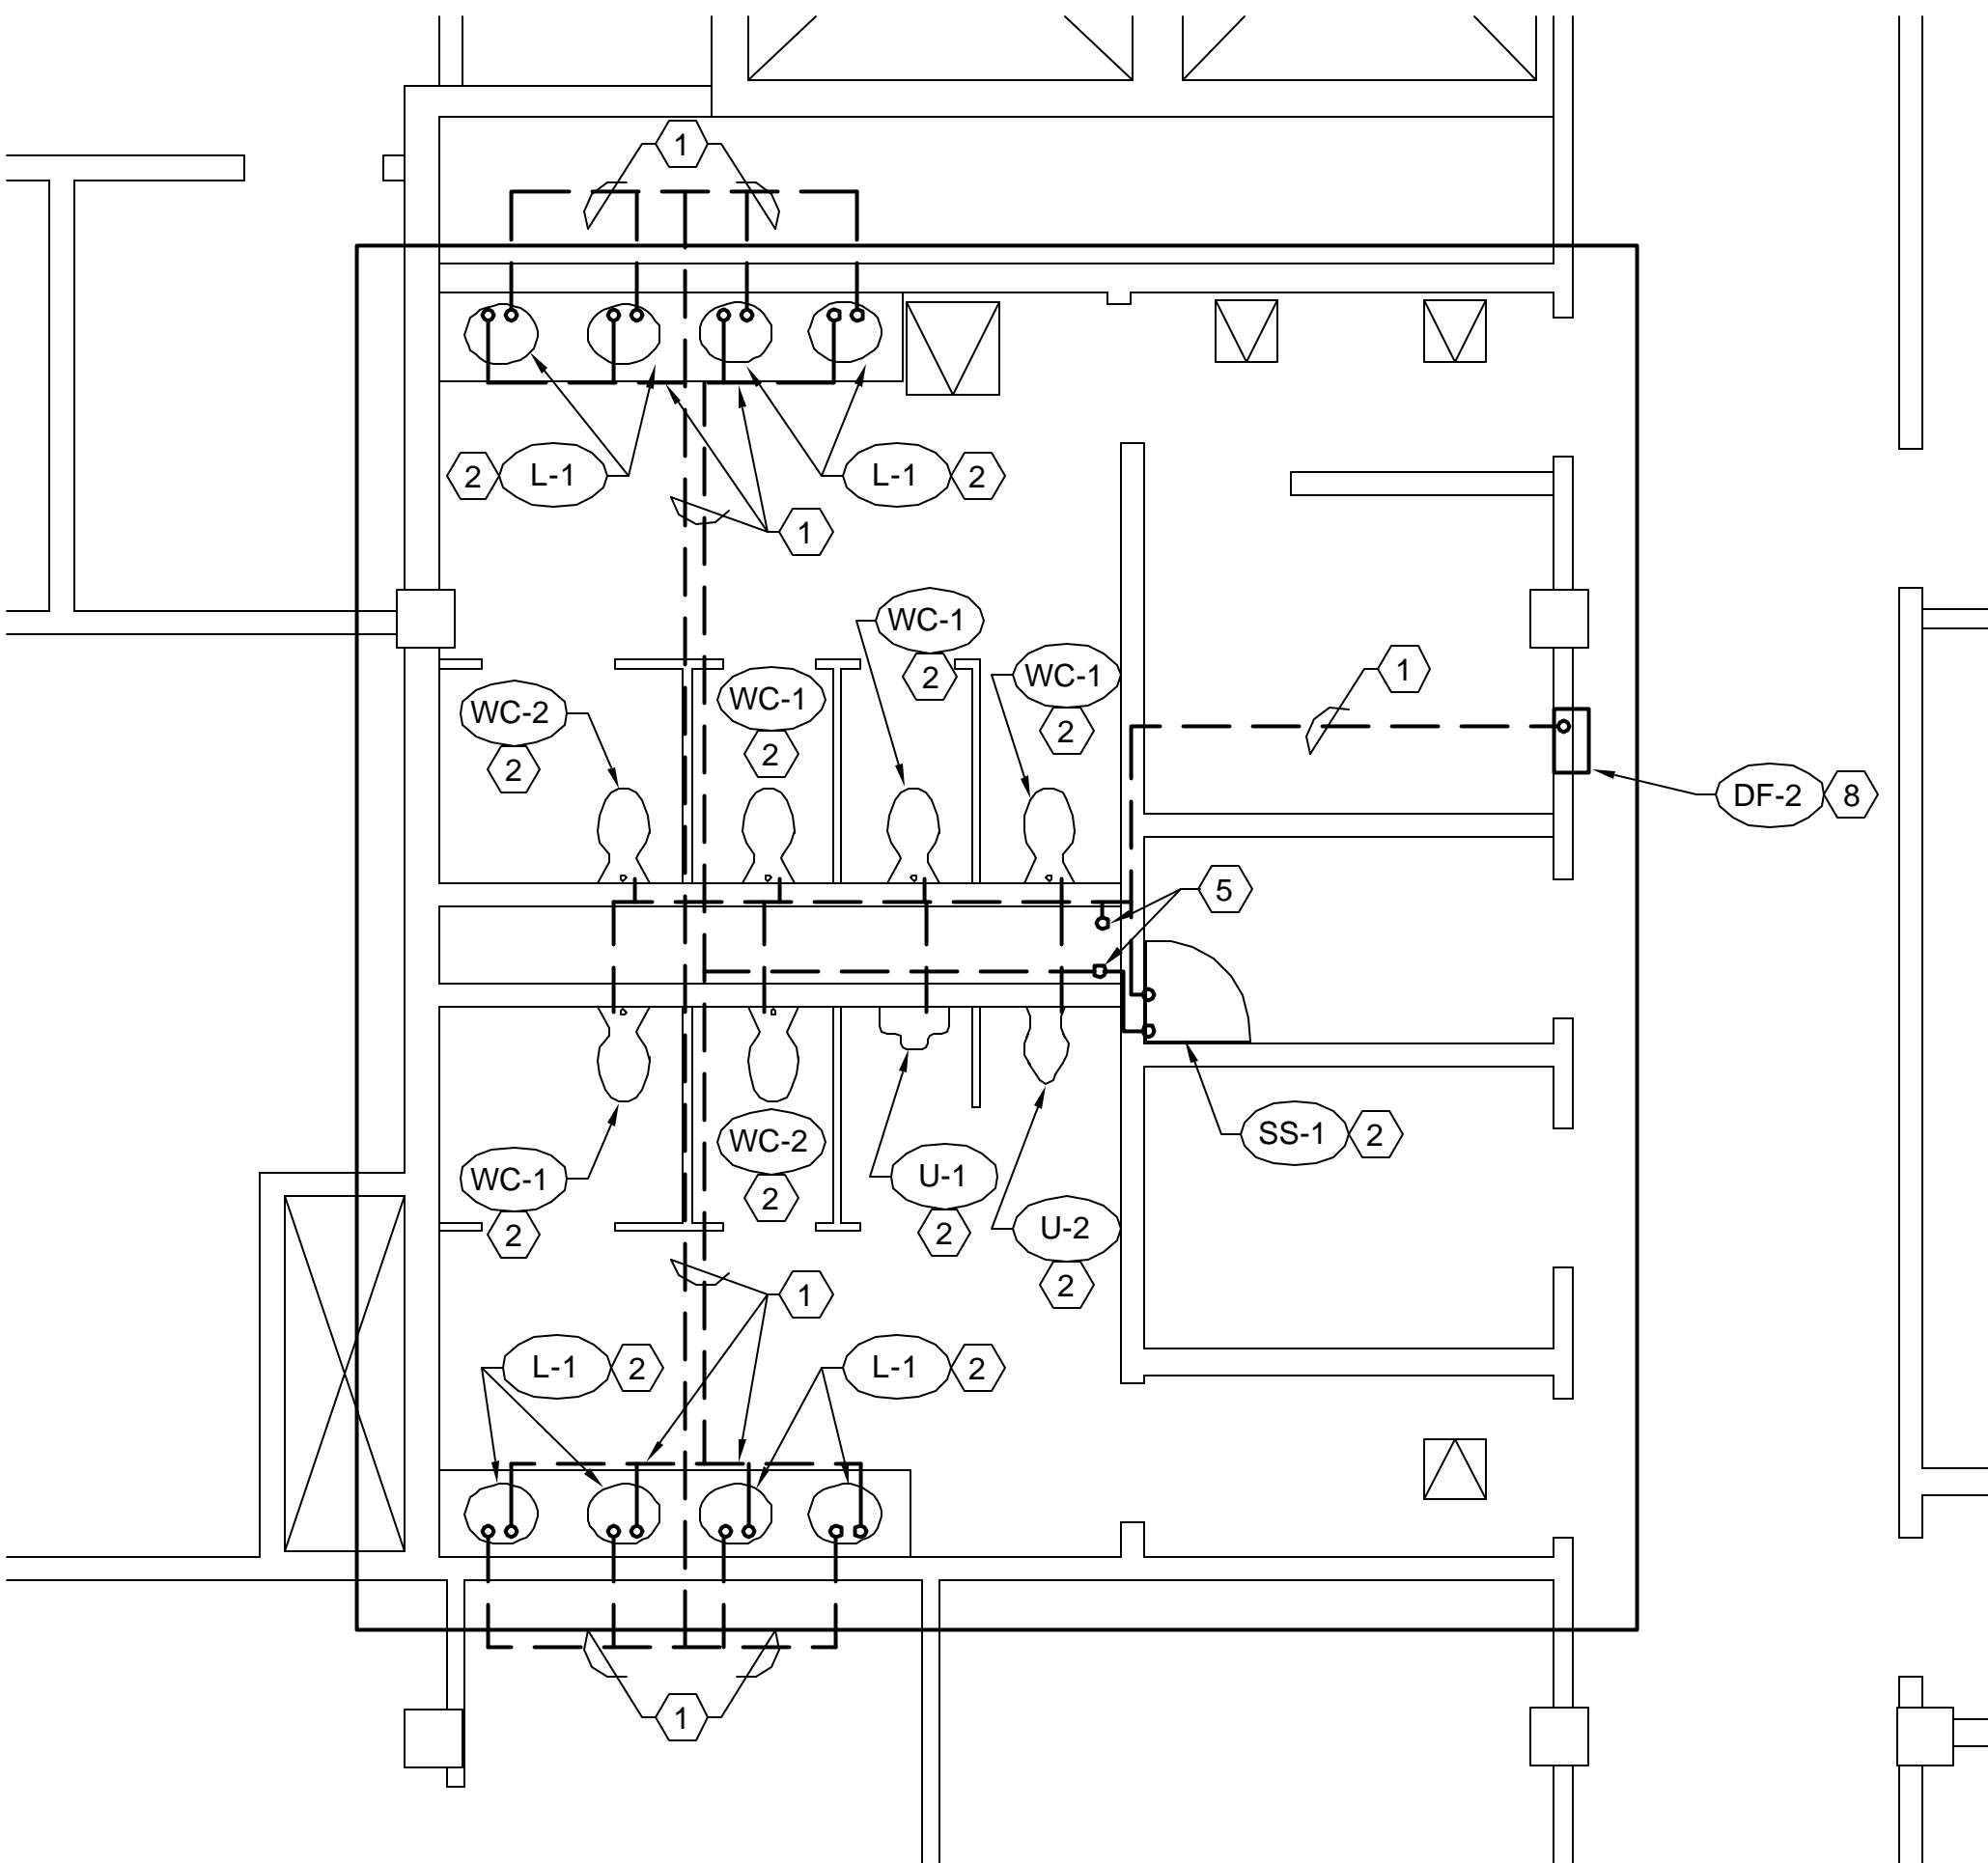

**DNR ENLARGED THIRD FLOOR
RESTROOM PIPING DEMO. PLAN**


SCALE: 1/4" = 1'-0"



C1 FIRST FLOOR PLUMBING SERVICE CLOSET
SCALE: NONE



C2 FIRST FLOOR PLUMBING SERVICE CLOSET
SCALE: NONE

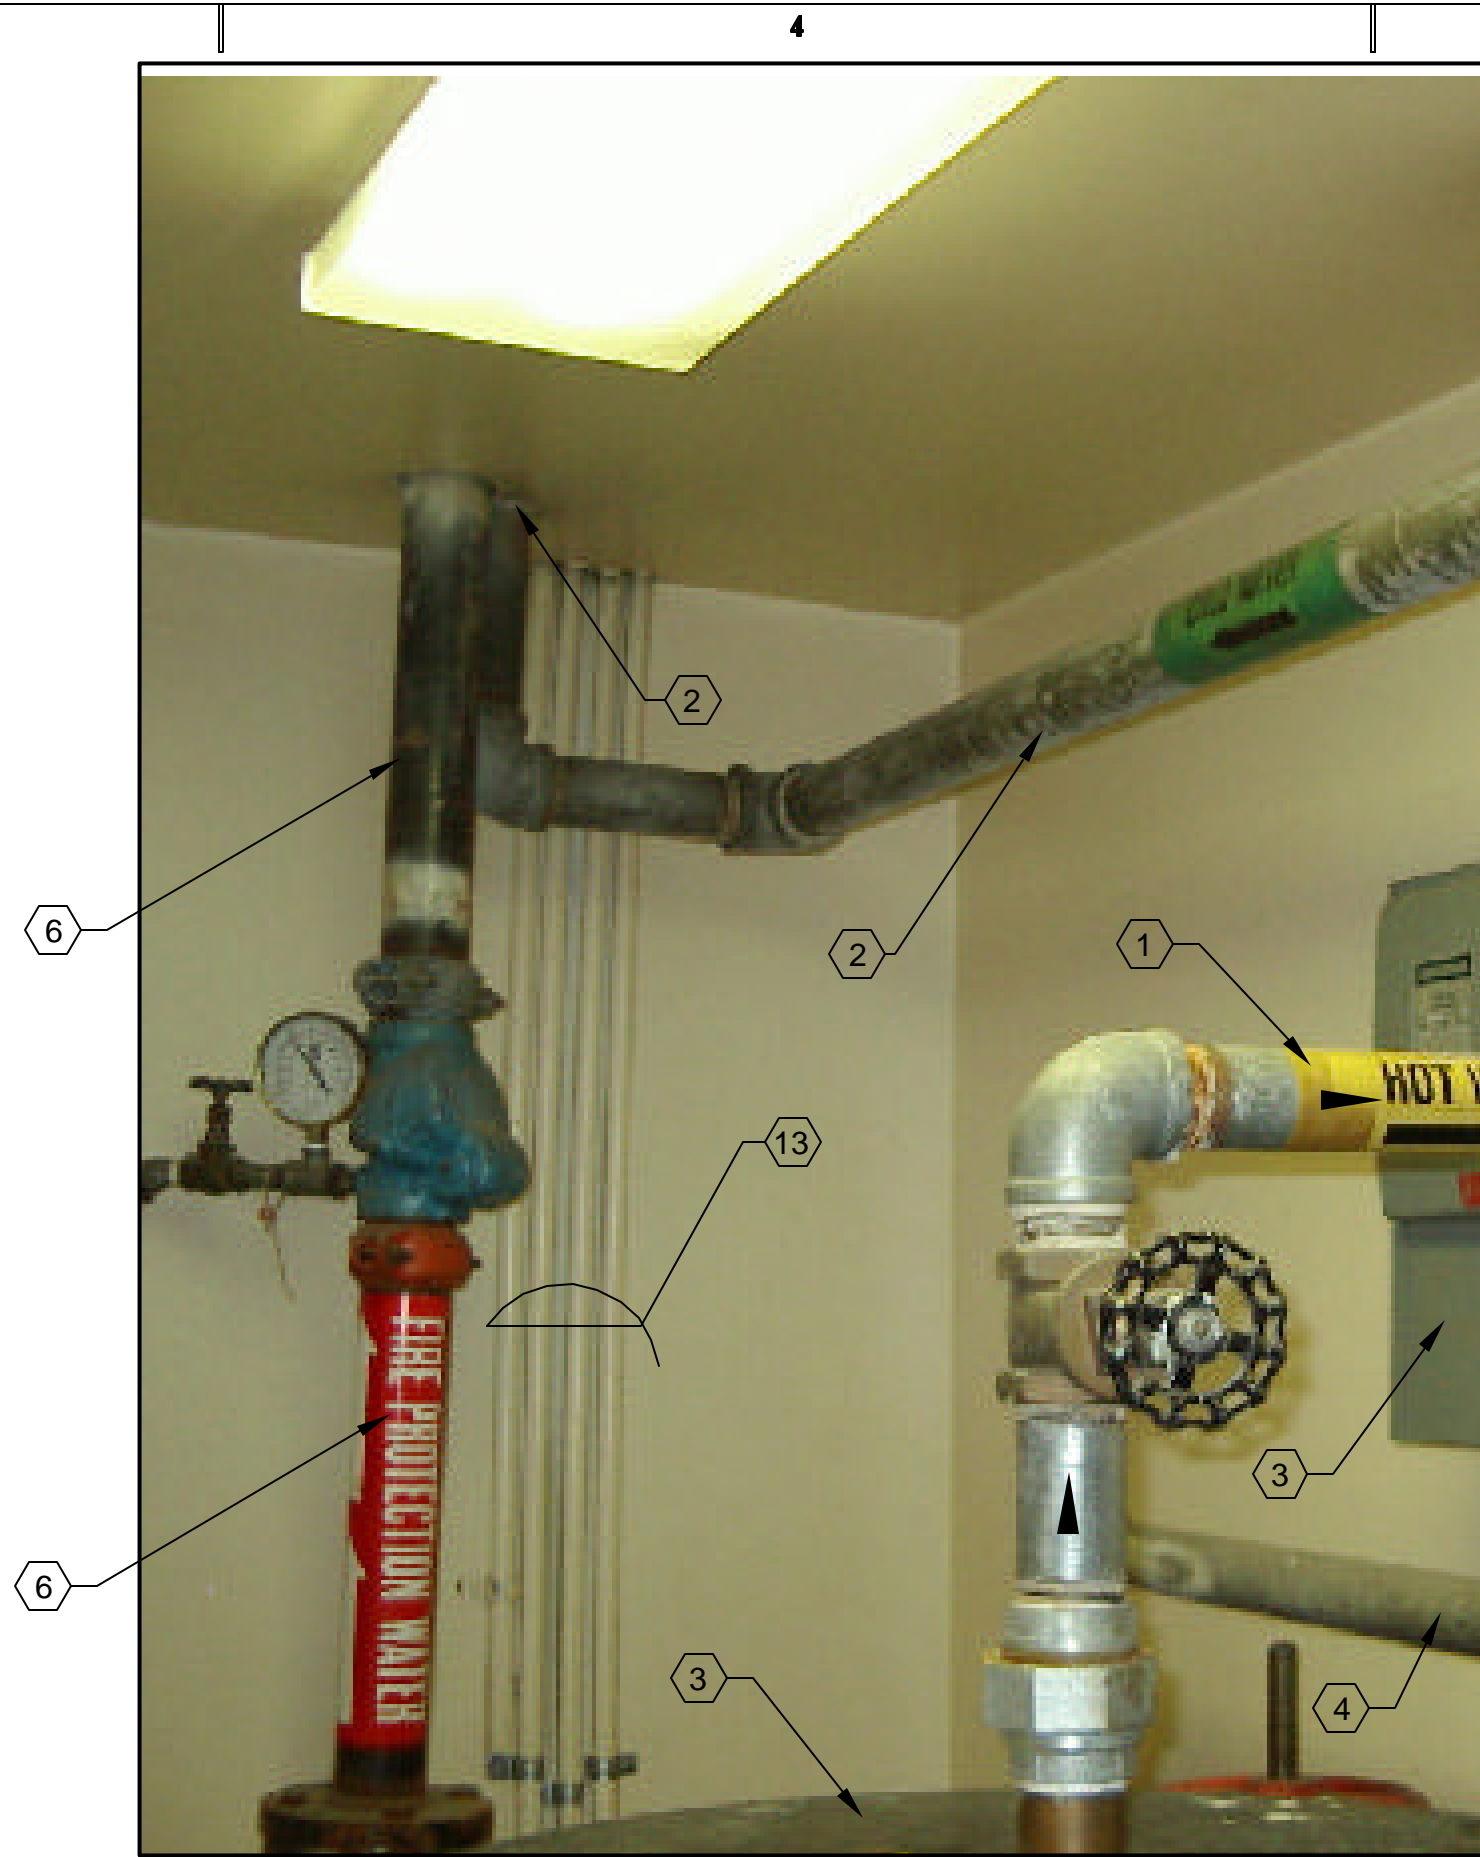

C4 FIRST FLOOR PLUMBING SERVICE CLOSET
SCALE: NONE



A1 FIRST FLOOR PLUMBING SERVICE CLOSET & WATER ENTRANCE AND HEADER.
SCALE: NONE



A2 FIRST FLOOR CEILING OPENING
SCALE: NONE



A4 FIRST FLOOR CEILING OPENING
SCALE: NONE

SHEET NOTES

- 1 REMOVE THE EXISTING 1-1/2" GALVANIZED HOT WATER SUPPLY TO BUILDING. USE SAME CEILING OPENING FOR NEW COPPER PIPING.
- 2 REMOVE THE EXISTING 2" GALVANIZED COLD WATER SUPPLY TO BUILDING. USE SAME CEILING OPENING FOR NEW COPPER PIPING.
- 3 REMOVE EXISTING ELECTRICAL HOT WATER HEATER AND ALL ASSOCIATED PIPING, VALVES ETC. ELECTRICAL DISCONNECT AND CONDUIT SHALL BE PRESERVED AND USED FOR NEW HOT WATER HEATER.
- 4 REMOVE EXISTING 3" WATER HEADER-PRV STATION AND 1-1/2" BY-PASS WITH VALVE.
- 5 REMOVE EXISTING 1-1/2" COLD WATER SUPPLY TO HOT WATER HEATER.
- 6 EXISTING FIRE RISER SHALL REMAIN.
- 7 EXISTING 3" DUCTILE IRON WATER SERVICE PIPING TO BUILDING SHALL REMAIN.
- 8 EXISTING DUCTILE IRON PIPING SHALL REMAIN.
- 9 EXISTING COUPLING BETWEEN DUCTILE IRON AND GALVANIZED PIPING SHALL BE REMOVED AND A NEW FITTING BETWEEN THE DUCTILE IRON AND COPPER PIPING SHALL BE PROVIDED.
- 10 CEILING SPACE BETWEEN FIRE RATED CEILING AND THE FLOOR DECKING.
- 11 REMOVE ALL EXISTING GALVANIZED CULINARY HOT AND COLD WATER PIPING THROUGHTOUT THE BUILDING. EXISTING PIPING IS ROUTED BETWEEN THE FIRE RATED CEILING AND THE FLOOR METAL DECK. REMOVE PIPING IN WALLS FROM ABOVE AND BELOW IF POSSIBLE. IF PIPING CANNOT BE REMOVED WITHOUT REMOVING THE WALLS, CONTRACTOR SHALL CAP THE END OF THE PIPING AND THE PIPING ABANDONED IN PLACE.
- 12 FIRE RATED CEILING, CUT WHERE REQUIRED FOR REMOVAL OF PIPING CONTRACTOR SHALL PATCH AND SEAL ALL NEW AND EXISTING OPENINGS IN THE FIRE RATED CEILING, AFTER REMOVING THE EXISTING GALVANIZED PIPING.
- 13 EXISTING ELECTRICAL CONDUIT SHALL REMAIN,

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PROJECT NAME & ADDRESS

**DEPARTMENT OF
NATURAL RESOURCES
ADMIN. BUILDING
WATER SUPPLY
NETWORK REPLACEMENT**

DFCM# 0420500

SALT LAKE CITY, UTAH

MARK	DATE	REVISION

PROJECT MANAGER:

SLW

DRAWN BY:

STAFF

CHECKED BY:

SLW/WP


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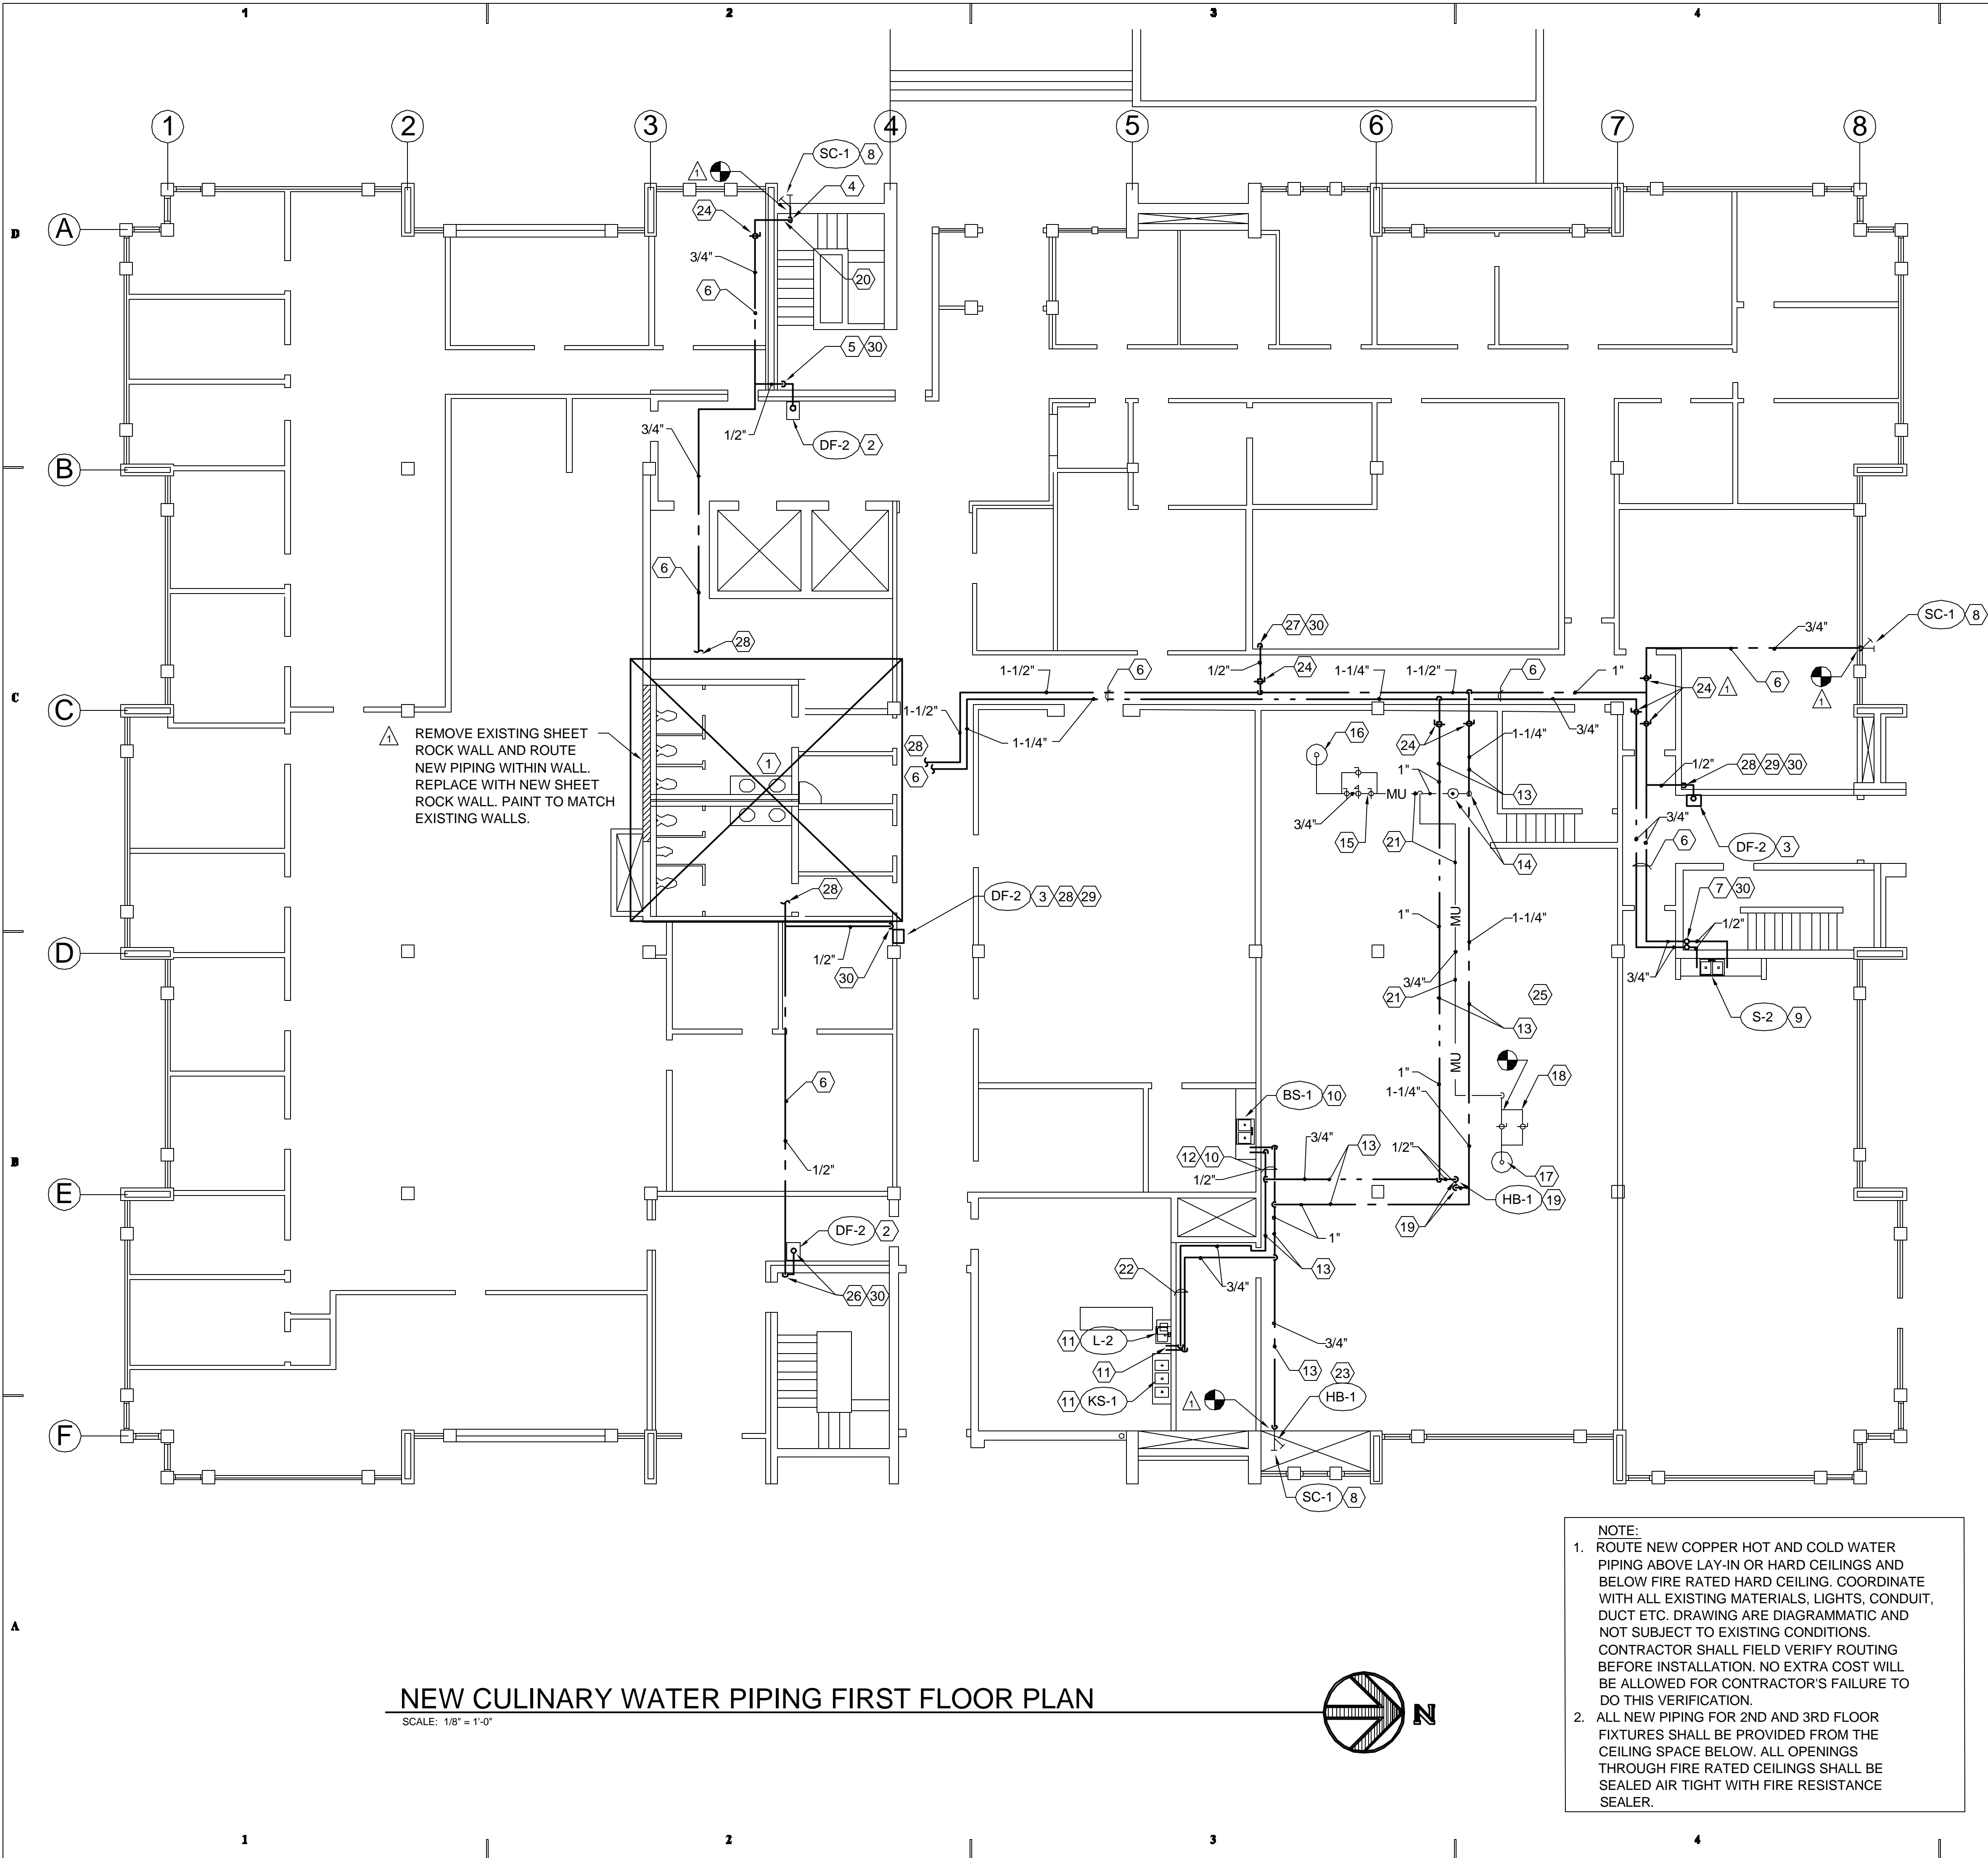
SHEET TITLE



CULINARY PIPING
DEMOLITION DETAILS

SHEET NO.

PD501

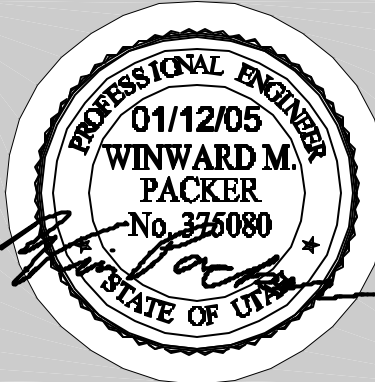

SHEET NOTES

- SEE C1/PE201 FOR LARGE SCALE REST ROOM NEW PIPING PLAN.
- EXISTING DRINKING FOUNTAIN DF-2 SHALL REMAIN.
- NEW DRINKING FOUNTAIN DF-2 WALL MOUNTED.
- DROP NEW 3/4" COLD WATER PIPING IN STAIRWELL TO EXISTING SILLCOCK IN STAIRWELL.
- DROP 1/2" COLD WATER PIPING TO 1ST FLOOR DRINKING FOUNTAIN DF-2 AND RISE TO SERVE DF-2 ON SECOND FLOOR AND DF-2 ON THIRD FLOOR. SEE SHEETS PE102 AND PE103 FOR CONTINUATION.
- ROUTE NEW COPPER WATER PIPING IN FIRST FLOOR CEILING SPACE.
- 3/4" COLD WATER RISER IN STAIRWELL TO SECOND FLOOR CEILING SPACE. DROP 1/2" COLD WATER AND HOT WATER TO SERVE S-2. PENETRATE STAIRWELL WALL. PIPING WILL BE LOCATED IN BOTTOM OF CABINET. RISE TO 2ND FLOOR CEILING TO SERVE DF-1 AND SINK S-3. SEE SHEET PE102 FOR CONTINUATION.
- EXISTING SILLCOCK SHALL REMAIN. PROVIDE NEW 3/4" COLD WATER PIPING.
- EXISTING SINK S-2 SHALL REMAIN. PROVIDE NEW PIPING AS SHOWN.
- EXISTING BREAK ROOM DOUBLE COMPARTMENT SINK BS-1 SHALL REMAIN. PROVIDE NEW PIPING AS SHOWN.
- EXISTING KITCHEN TRIPLE COMPARTMENT SINK KS-1 AND LAVATORY L-2 SHALL REMAIN. PROVIDE NEW PIPING AS SHOWN. ROUTE COPPER PIPING EXPOSED IN KITCHEN AND ROUTE UNDER SINK FOR TIE-INS.
- ROUTE NEW COPPER PIPING IN MECHANICAL ROOM AND PENETRATE WALL UNDER CABINET.
- NEW 1-1/4" COPPER PIPE TO MECHANICAL ROOM. PIPING SHALL BE ROUTED INSIDE THE ROOM AND EXPOSED.
- DROP 1" COLD WATER TO ONE COMMON 1" BACK FLOW PREVENTOR. SEE ISOMETRIC SHEET PE901.
- PROVIDE NEW HEATING HOT WATER SYSTEM MAKE-UP PRESSURE REGULATOR STATION. SEE DETAIL A2/PE501.
- EXISTING HEATING HOT WATER AIR SEPARATOR SHALL REMAIN. FIELD VERIFY EXACT LOCATION.
- EXISTING CHILLED WATER AIR SEPARATOR SHALL REMAIN. FIELD VERIFY EXACT LOCATION.
- EXISTING CHILLED WATER MAKE-UP PRESSURE REGULATOR STATION SHALL REMAIN AND BE RELOCATED. FIELD VERIFY EXACT LOCATION AND MAKE NEW CONNECTION.
- PROVIDE NEW HOT AND COLD WATER DROPS TO EXISTING SINGLE SINK. FIELD VERIFY LOCATION OF SINK. PROVIDE A COLD WATER HOSE BIBB AT BOTTOM OF COLD WATER DROP.
- 3/4" COLD WATER SUPPLY FOR DRINKING FOUNTAINS AND SILLCOCK. SEE PE201 FOR SOURCE.
- PROVIDE NEW 1" MAKE-UP WATER PIPING.
- ROUTE NEW 1/2" HOT AND COLD WATER TO KITCHEN. FOLLOW EXISTING PIPE ROUTING.
- PROVIDE NEW COLD WATER HOSE BIBB AT BOTTOM OF DROP.
- PROVIDE LINE SIZE BALL VALVES.
- ALL COLD, HOT AND MAKE-UP WATER LINES SHALL BE NEW COPPER PIPING.
- DROP NEW 1/2" COLD WATER DOWN STAIRWELL TO EXISTING DRINKING FOUNTAIN DF-2. SEE EXPOSED PIPING DETAIL A1/PE502. DRINKING FOUNTAINS FOR 2ND AND 3RD FLOORS HAVE PREVIOUSLY BEEN REMOVED.
- PROVIDE 1/2" COLD WATER TO HUMIDIFIER. PIPING SHALL BE EXPOSED IN COMPUTER ROOM.
- SEE C1/PE201 FOR CONTINUATION.
- PROVIDE 1/2" COLD WATER PIPING TO NEW DRINKING FOUNTAIN DF-2. DROP EXPOSED PIPING DOWN WALL TO DF-2. FILL IN OPENING WITH SS. BACK SPLASH, MADE BY THE REMOVAL OF THE EXISTING RECESSED DRINKING FOUNTAIN.
- PIPING IN ROOM SHALL BE COVERED WITH WHITE PVC CASING.

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PROJECT NAME & ADDRESS

**DEPARTMENT OF
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ADMIN. BUILDING
WATER SUPPLY
NETWORK REPLACEMENT**

DFCMM# 04205500

SALT LAKE CITY, UTAH


MARK	DATE	REVISION
1	1/12/05	1 - ADDED CONNECTION POINTS 2 - ADDED NOTE TO REMOVE WALL TO HIDE PIPING

PROJECT MANAGER:
SLW
DRAWN BY:
STAFF
CHECKED BY:
SLW/WP
DATE:
01/12/05
WHW JOB NO.:
04048



SHEET TITLE
**FIRST FLOOR NEW
CULINARY WATER
PIPING PLAN**

SHEET NO.
PE101

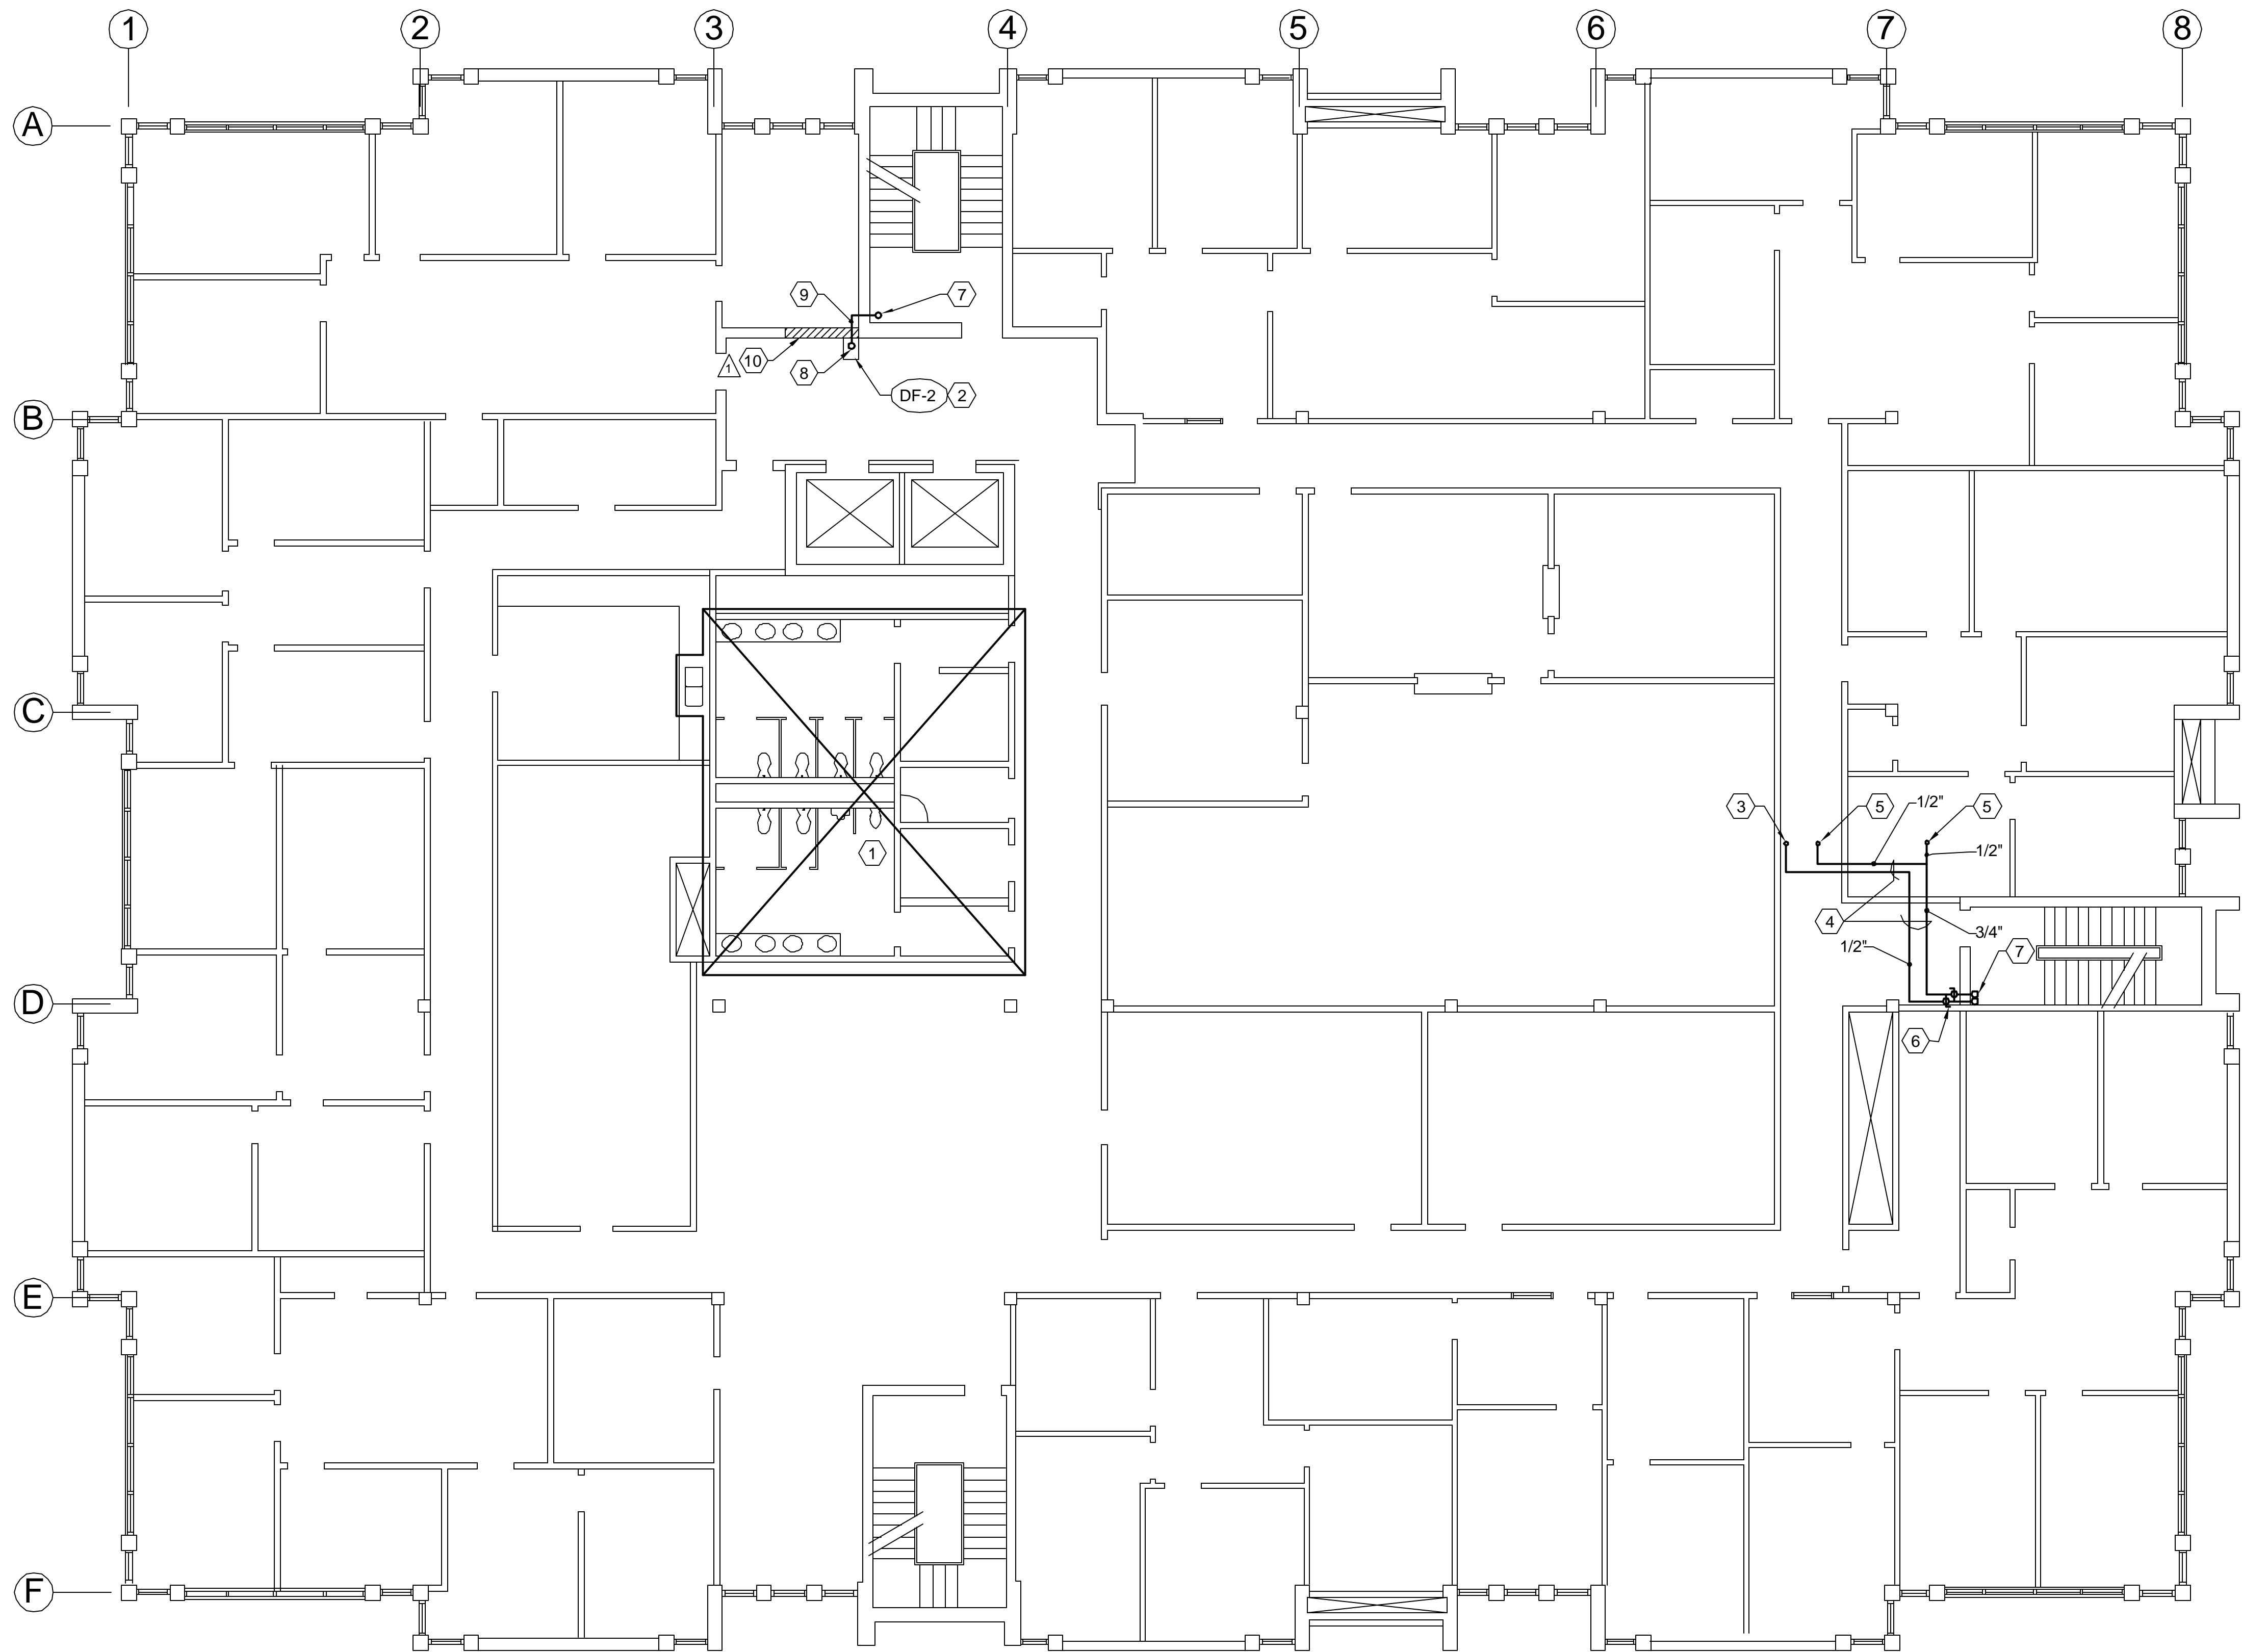

NEW CULINARY WATER PIPING SECOND FLOOR PLAN

SCALE: 1/8" = 1'-0"

- NOTE:**
- ROUTE NEW COPPER HOT AND COLD WATER PIPING ABOVE LAY-IN OR HARD CEILINGS AND BELOW FIRE RATED HARD CEILING. COORDINATE WITH ALL EXISTING MATERIALS, LIGHTS, CONDUIT, DUCT ETC. DRAWING ARE DIAGRAMMATIC AND NOT SUBJECT TO EXISTING CONDITIONS. CONTRACTOR SHALL FIELD VERIFY ROUTING BEFORE INSTALLATION. NO EXTRA COST WILL BE ALLOWED FOR CONTRACTOR'S FAILURE TO DO THIS VERIFICATION.
 - ALL NEW PIPING FOR 2ND AND 3RD FLOOR FIXTURES SHALL BE PROVIDED FROM THE CEILING SPACE BELOW. ALL OPENINGS THROUGH FIRE RATED CEILINGS SHALL BE SEALED AIR TIGHT WITH FIRE RESISTANCE SEALER.

SHEET NOTES

- SEE A1/PE201 FOR LARGE SCALE RESTROOM NEW PIPING PLAN.
- EXISTING DRINKING FOUNTAIN DF-2 SHALL REMAIN.
- 1/2" HOT WATER TO SINK S-3 ON THIRD FLOOR. SEE SHEET PE103 FOR CONTINUATION.
- ROUTE NEW HOT AND COLD WATER PIPING IN SECOND FLOOR CEILING SPACE.
- 1/2" COLD WATER TO SINK S-3 AND DRINKING FOUNTAIN DF-2 ON THIRD FLOOR. SEE SHEET PE103 FOR CONTINUATION.
- BALL VALVES WITH UNIONS.
- ROUTE RISERS IN STAIRWELL. COORDINATE WITH FIRE RISERS. SEE SHEET PE101 FOR SOURCE.
- 1/2" COLD WATER RISER FROM BELOW TO DRINKING FOUNTAIN. SEE DETAIL A1/PE502 FOR EXPOSED PIPING TO DRINKING FOUNTAIN. SEE SHEET PE101 FOR SOURCE.
- ROUTE IN 2ND FLOOR CEILING SPACE AND RISE UP TO DF-2 ON THE THIRD FLOOR. SEE SHEET PE301.
- REMOVE EXISTING SHEET ROCK WALL AND ROUTE NEW PIPING WITHIN WALL. REPLACE WITH NEW SHEET ROCK WALL. PAINT TO MATCH EXISTING WALLS.

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PROJECT NAME & ADDRESS

**DEPARTMENT OF
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ADMIN. BUILDING
WATER SUPPLY
NETWORK REPLACEMENT**

DFCM# 04200500

SALT LAKE CITY, UTAH

MARK	DATE	REVISION
1	1/12/05	ADDED NOTE FOR REMOVAL OF EXISTING SHEET ROCK WALL FOR HIDING PIPING

PROJECT MANAGER:

SLW

DRAWN BY:

STAFF

CHECKED BY:

SLW/WP


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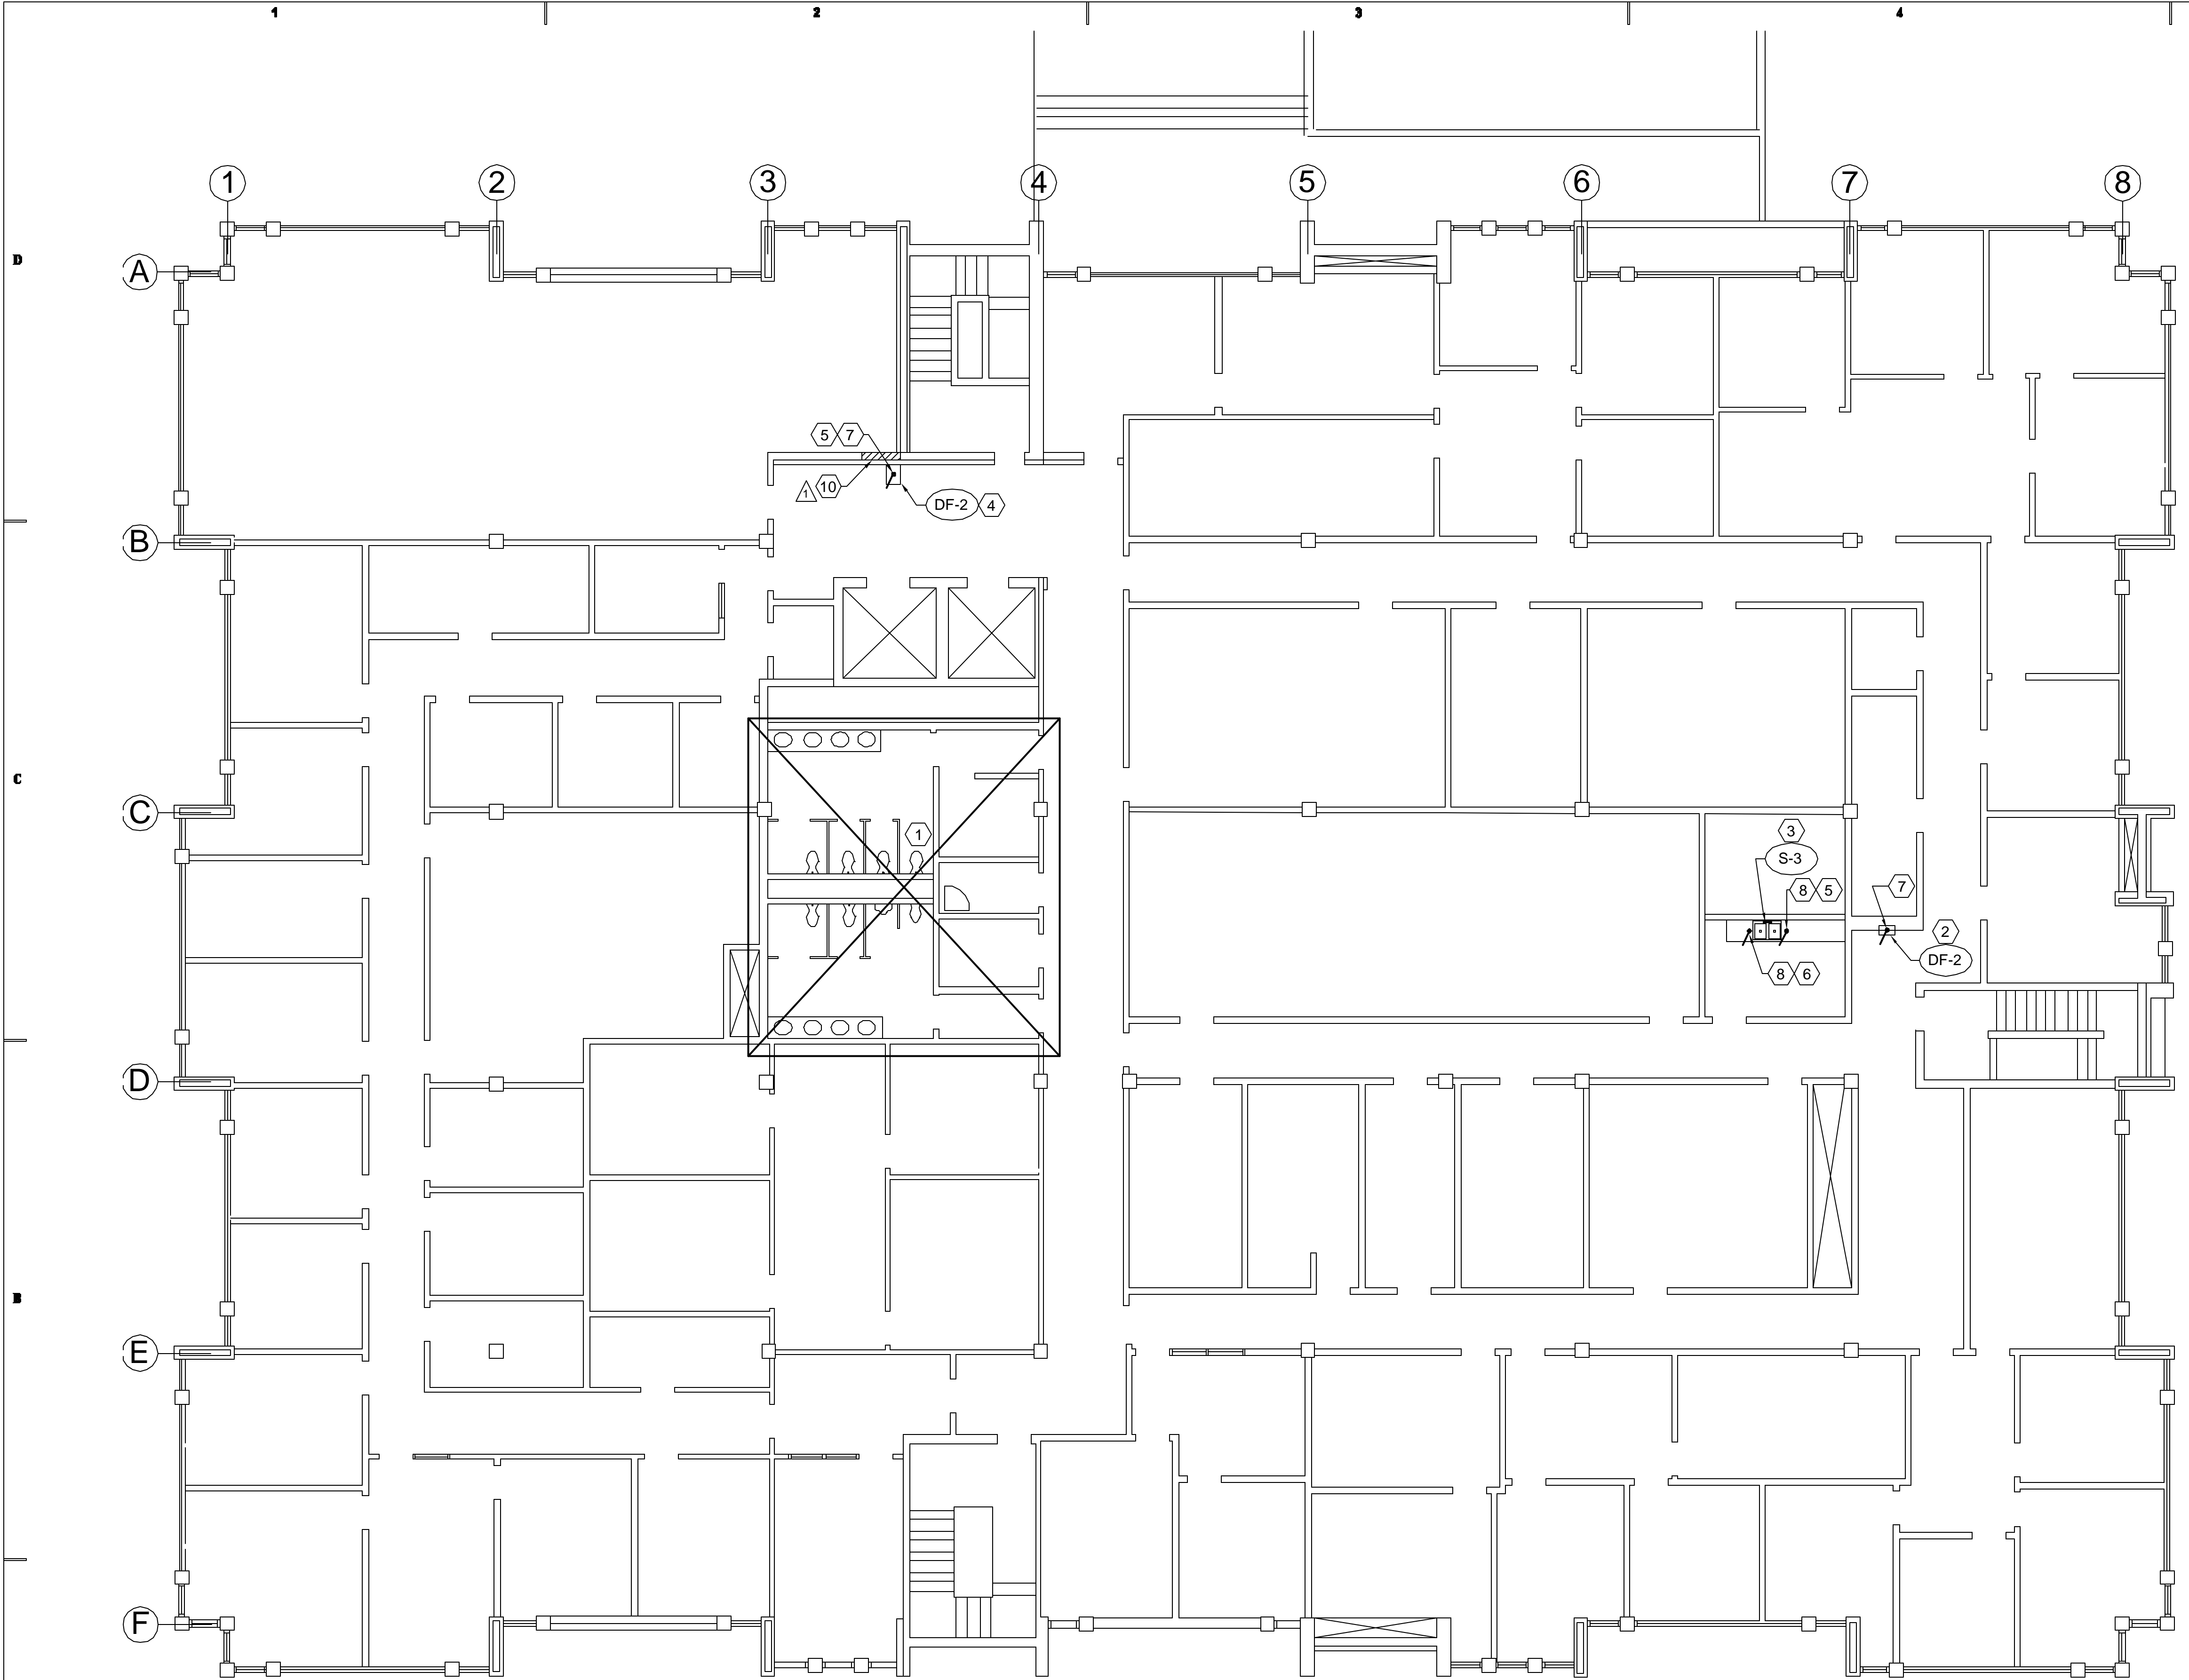
SHEET TITLE



SECOND FLOOR NEW
CULINARY WATER
PIPING PLAN

SHEET NO.

PE102

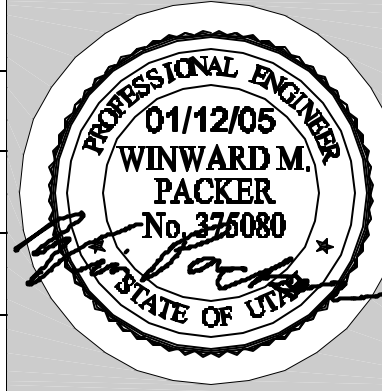

NEW CULINARY WATER PIPING THIRD FLOOR PLAN

SCALE: 1/8" = 1'-0"

NOTE:
1. ROUTE NEW COPPER HOT AND COLD WATER PIPING ABOVE LAY-IN OR HARD CEILINGS AND BELOW FIRE RATED HARD CEILING. COORDINATE WITH ALL EXISTING MATERIALS, LIGHTS, CONDUIT, DUCT ETC. DRAWING ARE DIAGRAMMATIC AND NOT SUBJECT TO EXISTING CONDITIONS. CONTRACTOR SHALL FIELD VERIFY ROUTING BEFORE INSTALLATION. NO EXTRA COST WILL BE ALLOWED FOR CONTRACTOR'S FAILURE TO DO THIS VERIFICATION.
2. ALL NEW PIPING FOR 2ND AND 3RD FLOOR FIXTURES SHALL BE PROVIDED FROM THE CEILING SPACE BELOW. ALL OPENINGS THROUGH FIRE RATED CEILINGS SHALL BE SEALED AIR TIGHT WITH FIRE RESISTANCE SEALER.

SHEET NOTES

- 1 SEE A3/PE201 FOR LARGE SCALE REST ROOM NEW PIPING PLAN.
- 2 NEW DRINKING FOUNTAIN DF-2.
- 3 EXISTING DOUBLE SINK S-3 SHALL REMAIN. PROVIDE NEW HOT AND COLD WATER PIPING.
- 4 EXISTING DRINKING FOUNTAIN DF-2 SHALL REMAIN.
- 5 NEW 1/2" COLD WATER PIPING FROM SECOND FLOOR CEILING. SEE SHEET PE102 FOR SOURCE.
- 6 NEW 1/2" HOT WATER PIPING FROM SECOND FLOOR CEILING. SEE SHEET PE102 FOR SOURCE.
- 7 SEE DETAIL A1/PE502 FOR NEW PIPING ARRANGEMENT TO DRINKING FOUNTAIN.
- 8 ROUTE NEW 1/2" HOT AND COLD WATER FROM BELOW TO UNDER FLOOR OF CABINET. SEE ISOMETRIC PE901.
- 9 SEE WATER ISOMETRIC FOR ROUTING AND PIPE SIZES.
- 10 REMOVE EXISTING SHEETROCK WALL AND ROUTE NEW PIPING WITHIN WALL. REPLACE WITH NEW SHEETROCK WALL. PAINT TO MATCH EXISTING WALLS.

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ADMIN. BUILDING
WATER SUPPLY
NETWORK REPLACEMENT**

DFCM# 04200500

SALT LAKE CITY, UTAH

MARK	DATE	REVISION
1	1/12/05	ADDED NOTE FOR REMOVAL OF EXISTING SHEET ROCK WALL FOR HIDING PIPING

PROJECT MANAGER:

SLW

DRAWN BY:

STAFF

CHECKED BY:

SLW/WP


DATE:

01/12/05

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SHEET TITLE



THIRD FLOOR NEW
CULINARY WATER
PIPING PLAN

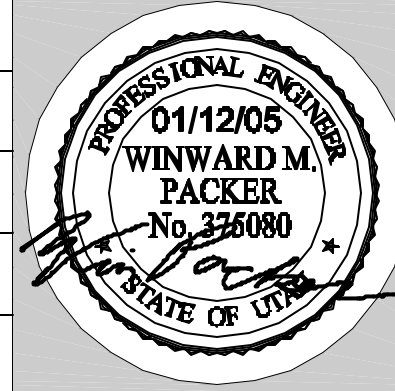SHEET NO.

PE103

SHEET NOTES

- 1

EXISTING LAVATORIES L-1 SHALL REMAIN AND FITTED WITH NEW HOT AND COLD WATER PIPING.
- 2

ROUTE HOT AND COLD WATER PIPING IN CEILING OF 2ND FLOOR.
- 3

1/2"Ø RISERS TO LAVATORIES. SEE DETAIL D1 AND D2/PE502. ALL EXPOSED PIPING IN TOILET ROOM SHALL BE CHROME PLATED OR STAINLESS STEEL.
- 4

2" COLD WATER RISER FROM SECOND FLOOR. SEE SHEET PE102 FOR SOURCE.
- 5

1" HOT WATER RISER FROM SECOND FLOOR. SEE SHEET PE102 FOR SOURCE.
- 6

ROUTE PIPING IN CHASE OF 2ND FLOOR CEILING AND PROVIDE RISERS AT ALL FIXTURE LOCATIONS.
- 7

ROUTE 1/2" COLD WATER IN SECOND FLOOR CEILING SPACE.
- 8

RISE UP THROUGH FLOOR AND CONNECT TO NEW DRINKING FOUNTAIN DF-2. SEE DETAIL A1/PE502.
- 9

EXISTING WATER CLOSET WC-1 AND WC-2 SHALL REMAIN AND FITTED WITH NEW COLD WATER PIPING. SEE DETAIL A2/PE502 AND B1/PE501 FOR DETAIL AT 1ST FLOOR WATER CLOSETS.
- 10

EXISTING URINAL U-1 SHALL REMAIN AND FITTED WITH NEW COLD WATER PIPING.
- 11

EXISTING URINAL U-2 SHALL REMAIN AND FITTED WITH NEW COLD WATER PIPING.
- 12

PROVIDE NEW DRINKING FOUNTAIN DF-2 AND COLD WATER SUPPLY.
- 13

ROUTE HOT AND COLD WATER PIPING UNDER FLOOR IN CEILING OF 1ST FLOOR.
- 14

2"Ø COLD WATER RISER FROM 1ST FLOOR. SEE SHEET PE101 FOR SOURCE AND PE103 FOR CONTINUATION.
- 15

1"Ø HOT WATER RISER FROM 1ST FLOOR. SEE SHEET PE101 FOR SOURCE AND PE103 FOR CONTINUATION.
- 16

ROUTE PIPING IN CHASE OF 1ST FLOOR CEILING AND PROVIDE RISERS AT ALL FIXTURE LOCATIONS.
- 17

ROUTE NEW 1/2" COLD AND HOT WATER PIPING IN 1ST FLOOR CEILING SPACE AND RISE UP IN CABINET BOTTOM TO SERVE EXISTING SINK S-1.
- 18

EXISTING SINK S-1 SHALL REMAIN AND FITTED WITH NEW HOT AND COLD WATER PIPING.
- 19

PROVIDE 1/2" HOT AND COLD WATER PIPING TO EXISTING SERVICE SINK FROM PLUMBING SHAFT USE EXISTING WALL OPENINGS WHERE POSSIBLE.
- 20

NEW ELECTRIC WATER HEATER. SEE SCHEDULE SHEET PE501 AND PIPING DETAIL C3/PE501.
- 21

CONNECT TO EXISTING DUCTILE IRON PIPING AS SHOWN ON DETAIL C1/PE501.
- 22

NEW 3" COPPER PIPE HEADER AND PRESSURE REDUCING VALVE. SEE DETAIL C1/PE501.
- 23

EXISTING FIRE RISER SHALL REMAIN.
- 24

EXISTING FLOOR DRAIN SHALL REMAIN.
- 25

REMOVE EXISTING SHEET ROCK WALL AND ROUTE NEW PIPING WITHIN WALL. REPLACE WITH NEW SHEET ROCK WALL. PAINT TO MATCH EXISTING WALLS
- 26

DROP COLD WATER PIPING DOWN INSIDE WALL
- 27

3/4" COLD WATER PIPING TO DRINKING FOUNTAINS AND SILCOCK WEST SIDE OF BLDG. SEE SHEET PE-101 FOR CONTINUATION.
- 28

1/2" COLD WATER PIPING TO DRINKING FOUNTAINS, EAST SIDE. SEE SHEET PE101 FOR CONTINUATION.
- 29

SEE C-3 THIS SHEET FOR CONTINUATION.
- 30

ROUTE HOT AND COLD WATER PIPING UNDER COUNTER FOR 1ST FLOOR L-1'S. PIPING SHALL BE STAINLESS STEEL OR CHROME PLATED COPPER.
- 31

ROUTE PIPING WITHIN THE JANITORS ROOM AS HIGH AS POSSIBLE.
- 32


ROUTE NEW PIPING EXPOSED TO EXISTING SERVICE SINK. SEE DETAIL D4/PE502.

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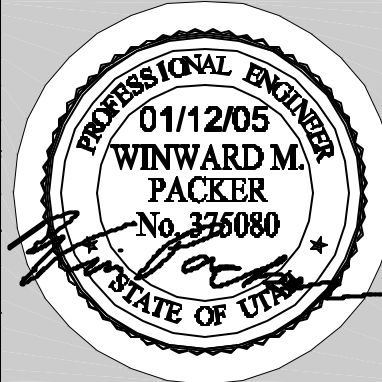
DEPARTMENT OF
NATURAL RESOURCES
ADMIN. BUILDING
WATER SUPPLY
NETWORK REPLACEMENT

DFCM# 01296500

SALT LAKE CITY, UTAH

MARK	DATE	REVISION
1	1/12/05	1 - ADDED NOTE TO REMOVE WALL TO HIDE PIPING

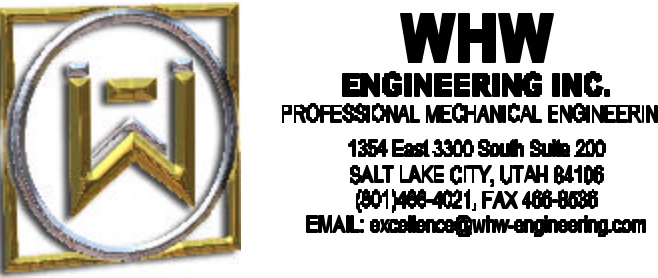
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SHEET TITLE



ENLARGED CULINARY
PIPING RESTROOM
PLANS


SHEET NO.

PE201

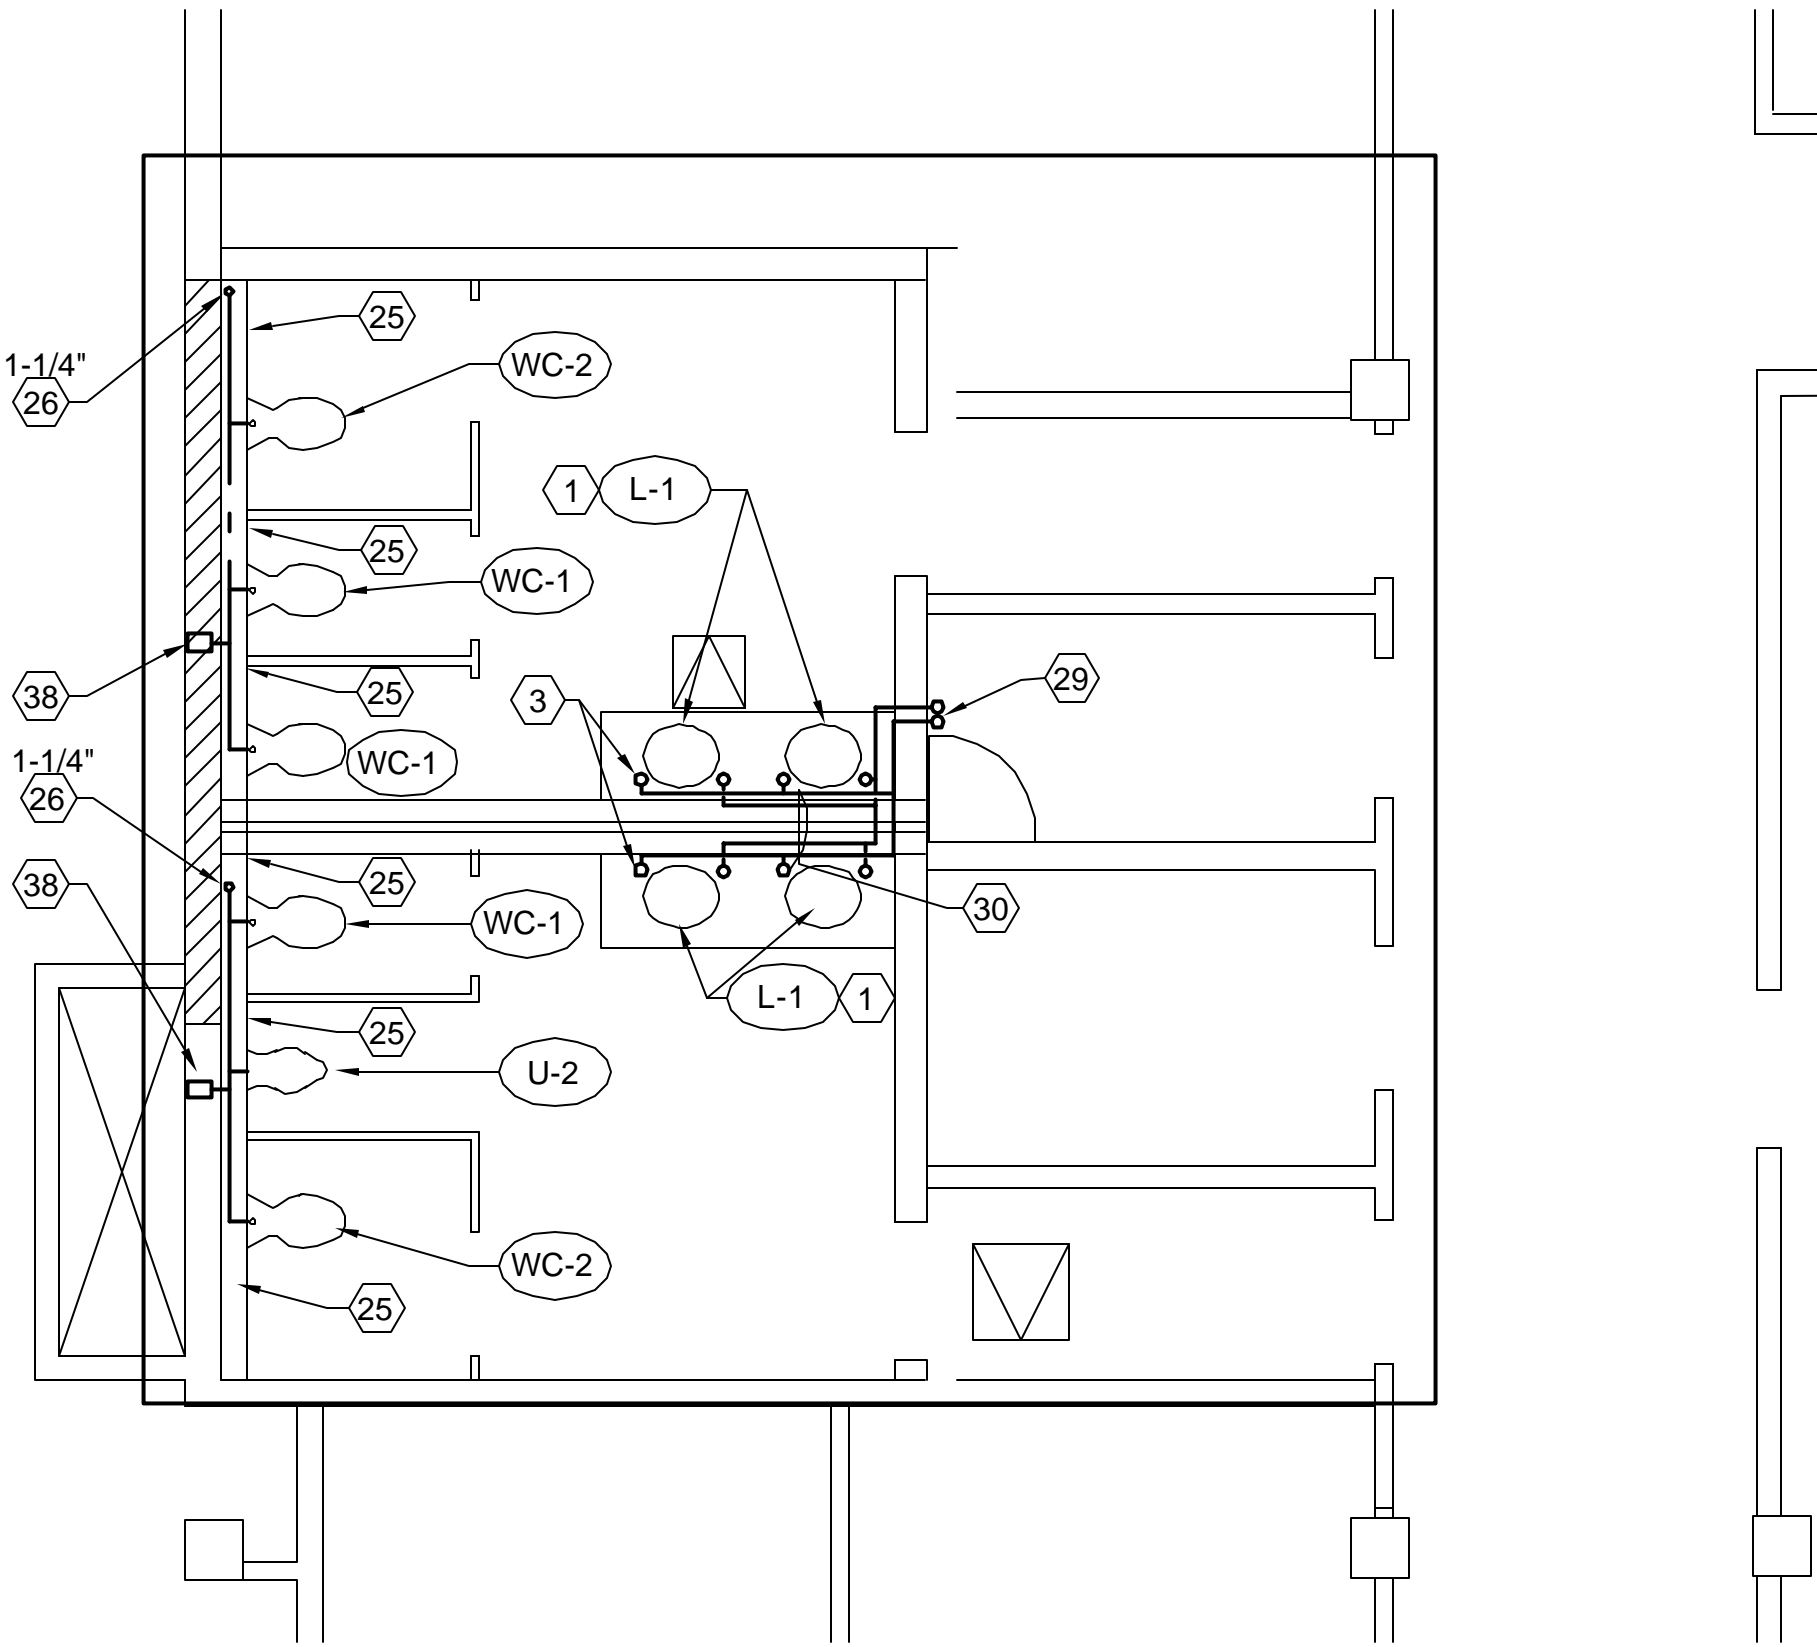


DNR ENLARGED FIRST FLOOR
RESTROOM NEW PIPING PLAN

SCALE: 1/4" = 1'-0"

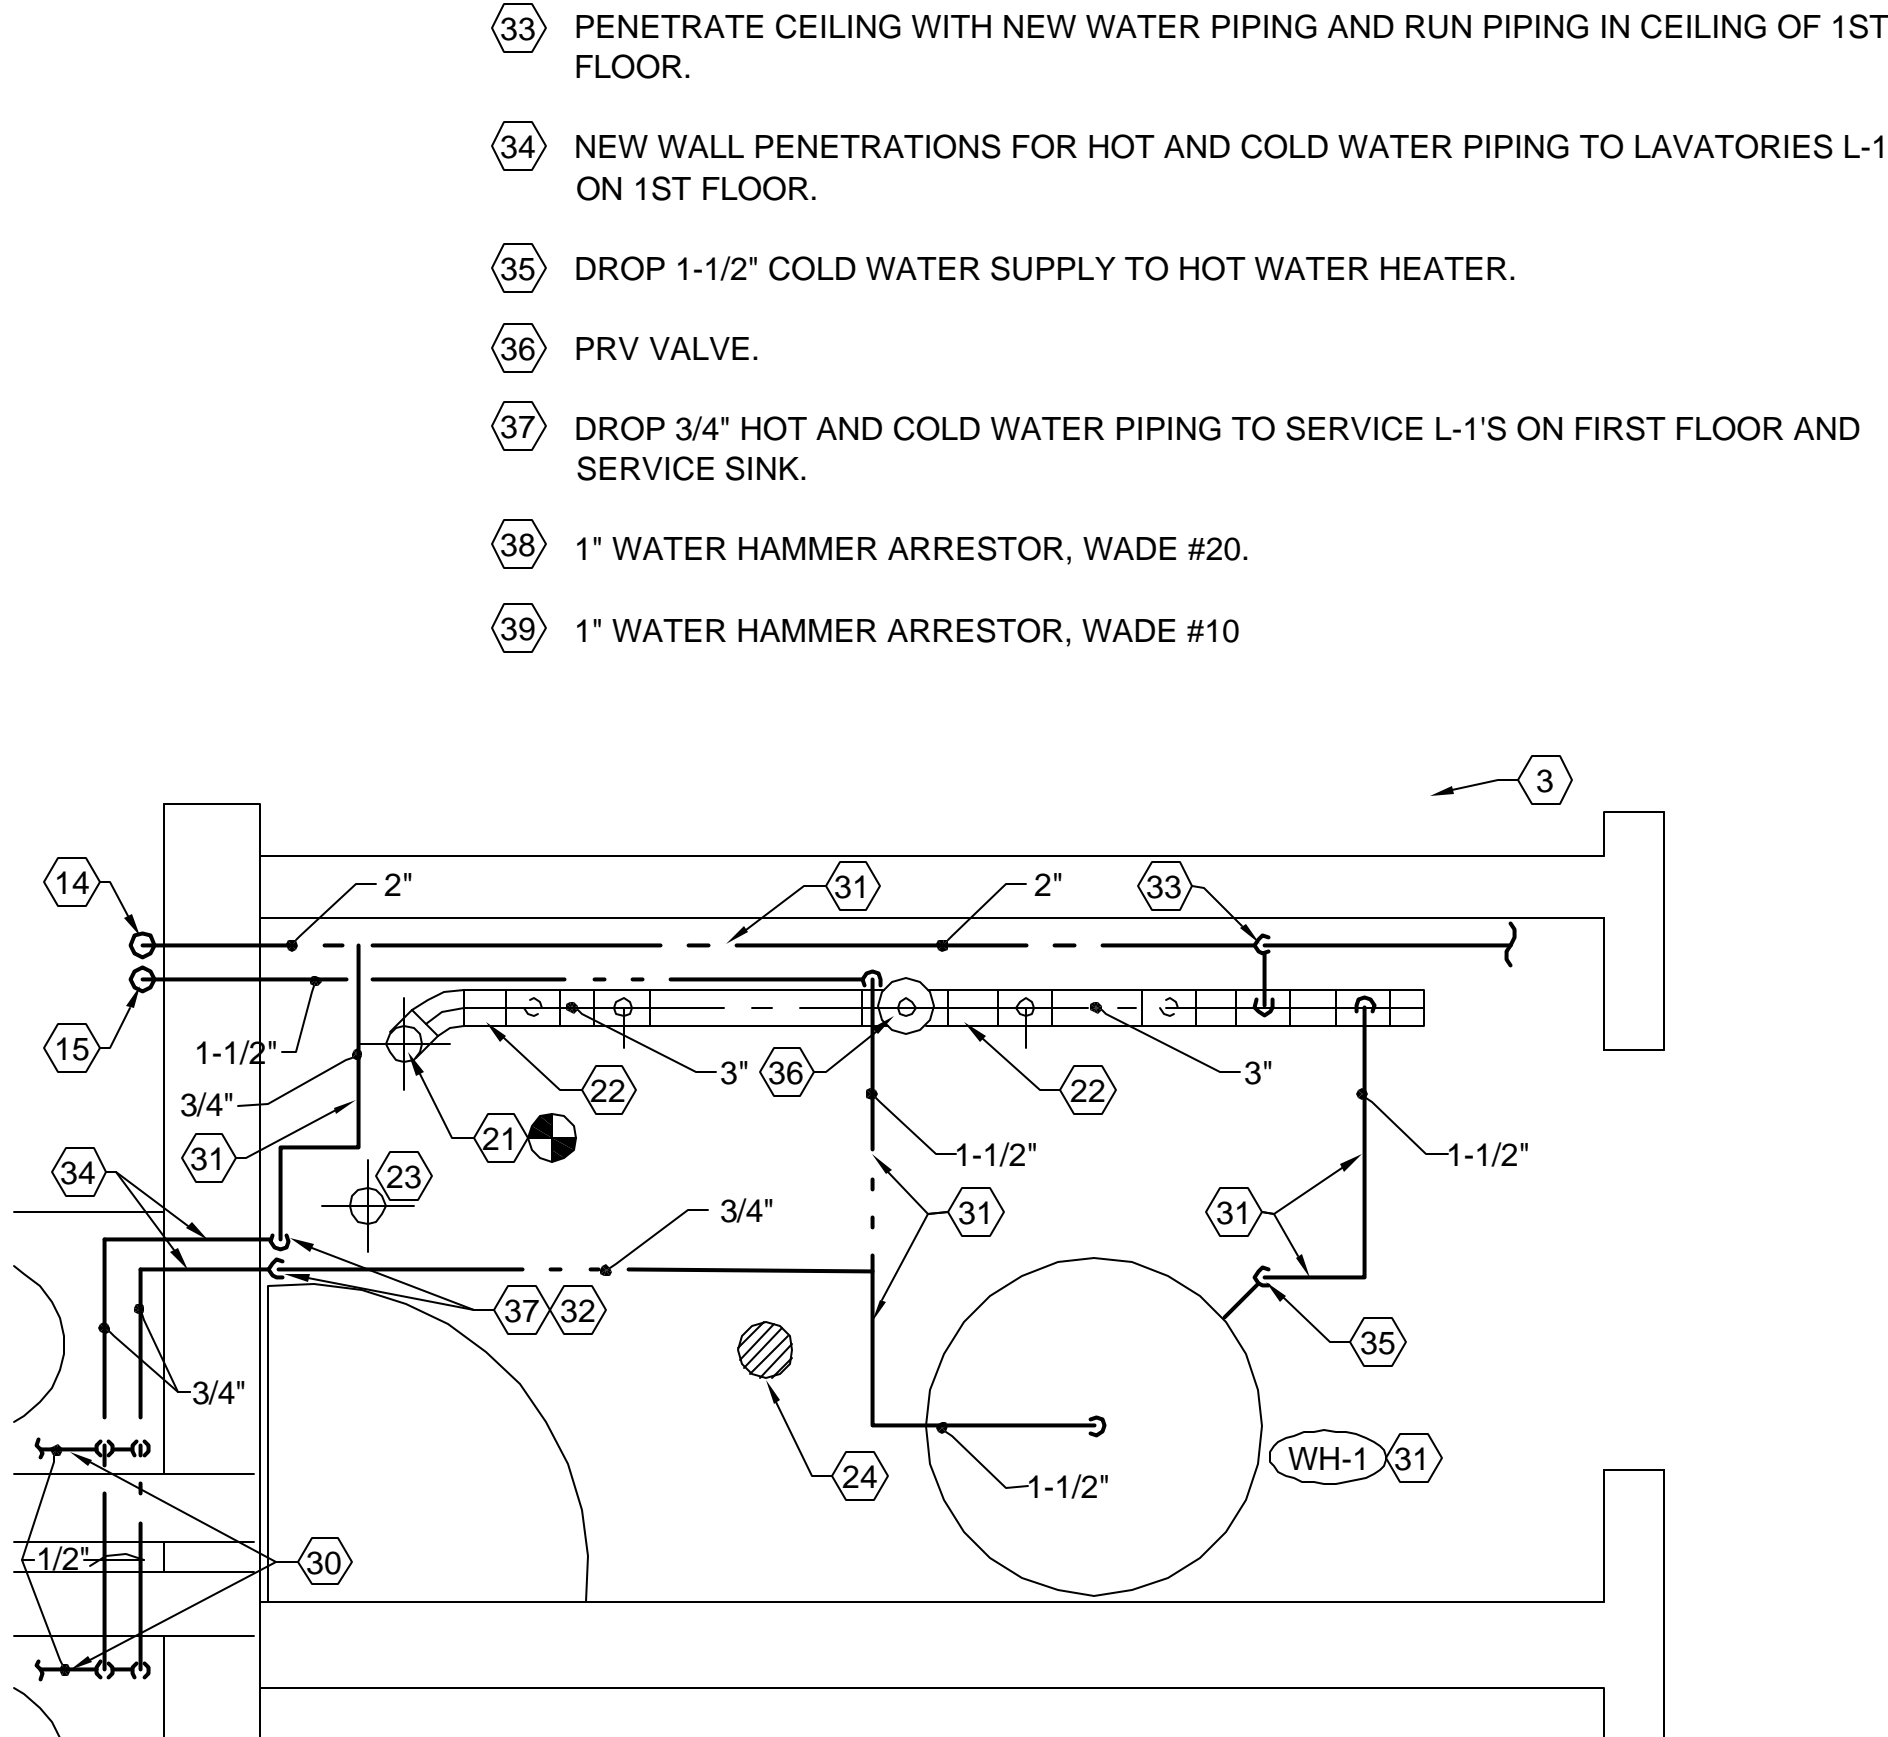


DNR ENLARGED FIRST FLOOR
JANITORS ROOM NEW PIPING PLAN

SCALE: 3/4" = 1'-0"

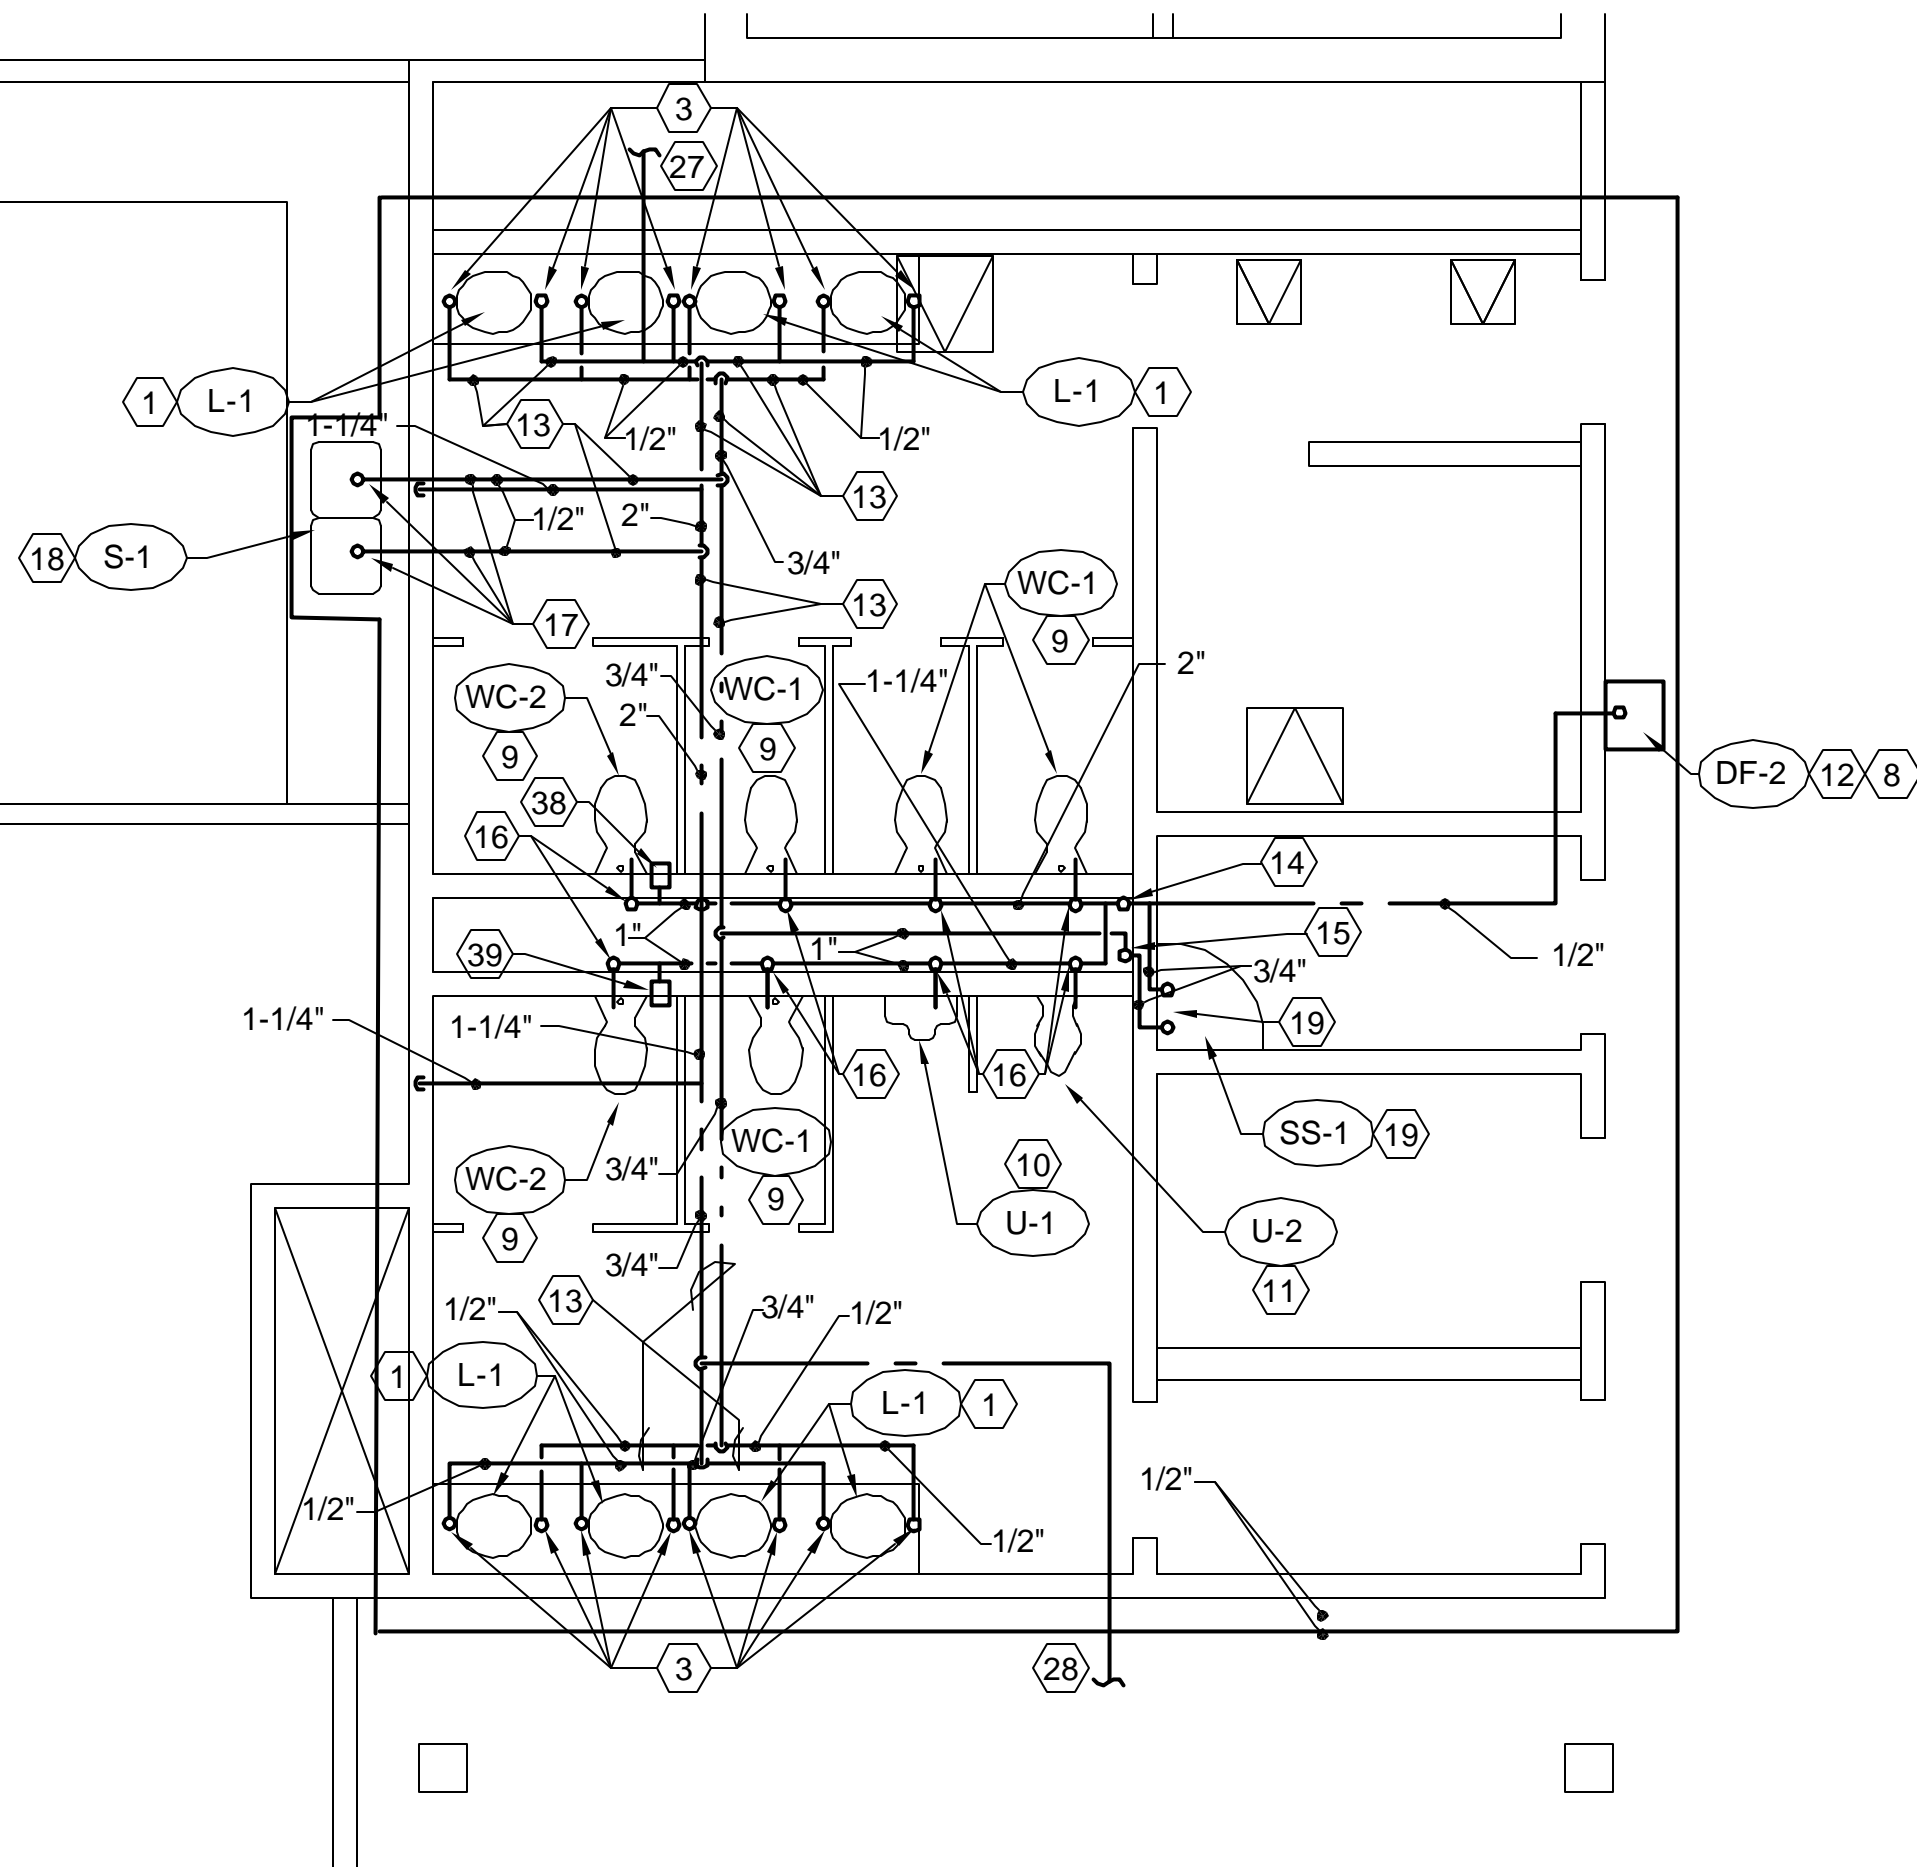


DNR ENLARGED SECOND FLOOR
RESTROOM NEW PIPING PLAN

SCALE: 1/4" = 1'-0"

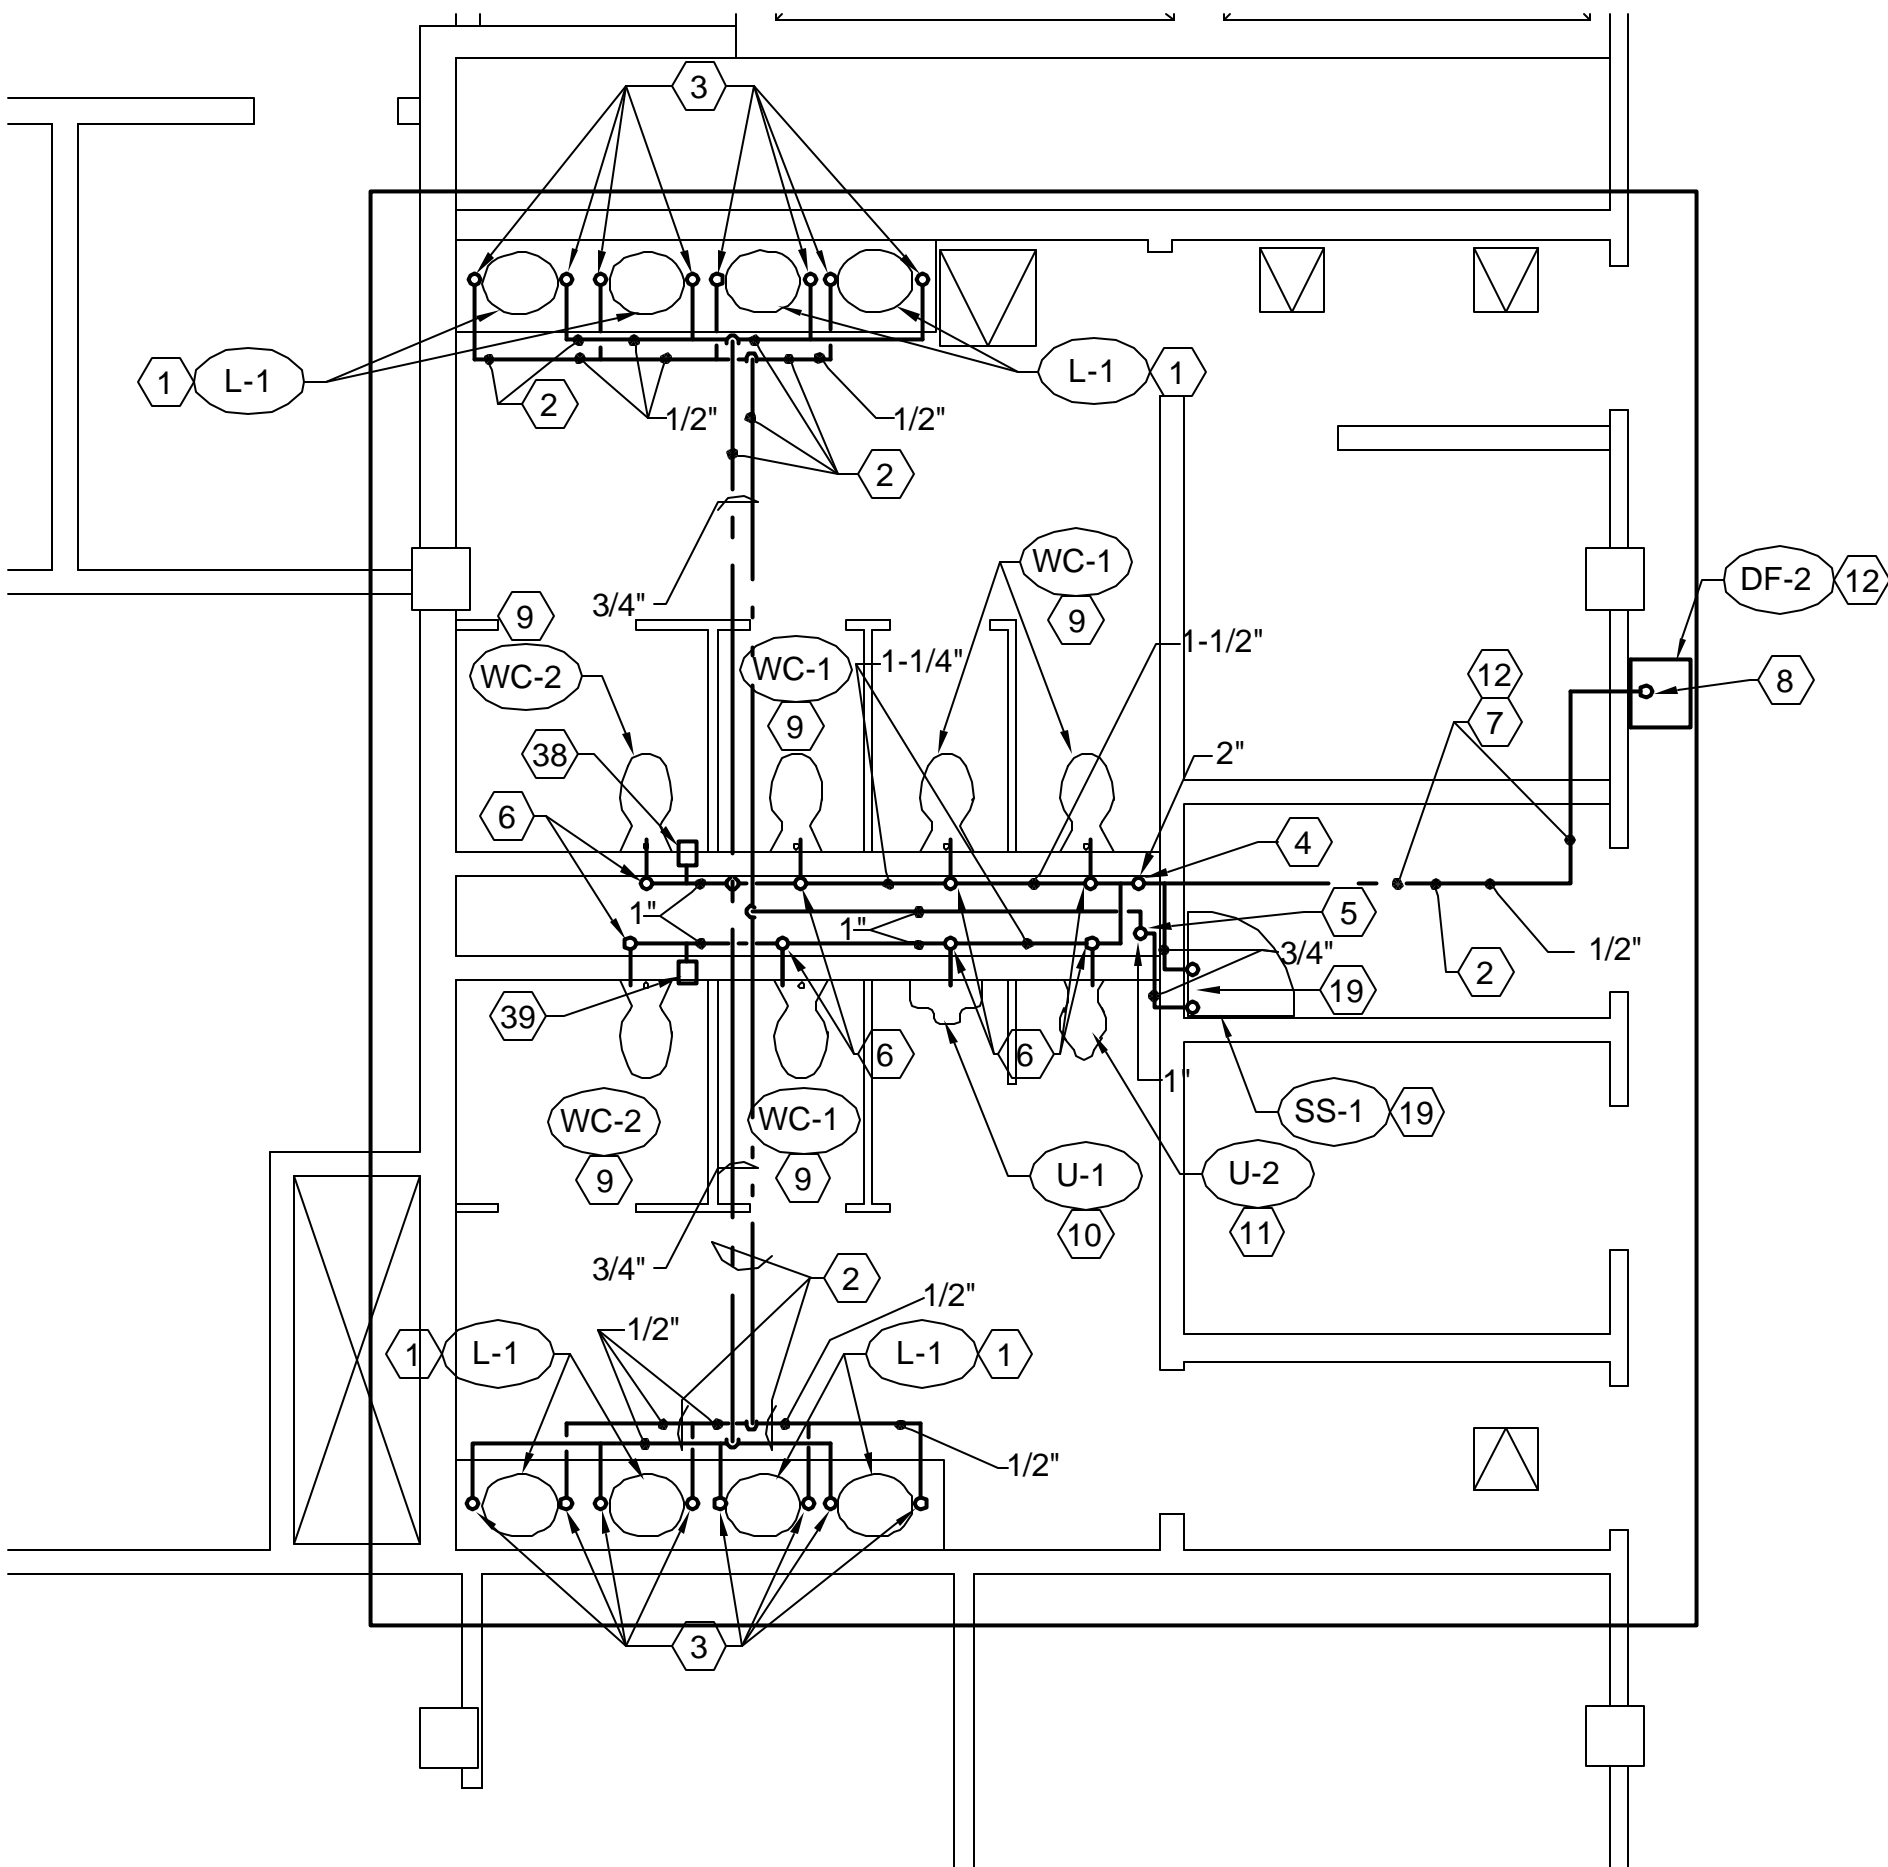


DNR ENLARGED THIRD FLOOR
RESTROOM NEW PIPING PLAN

SCALE: 1/4" = 1'-0"

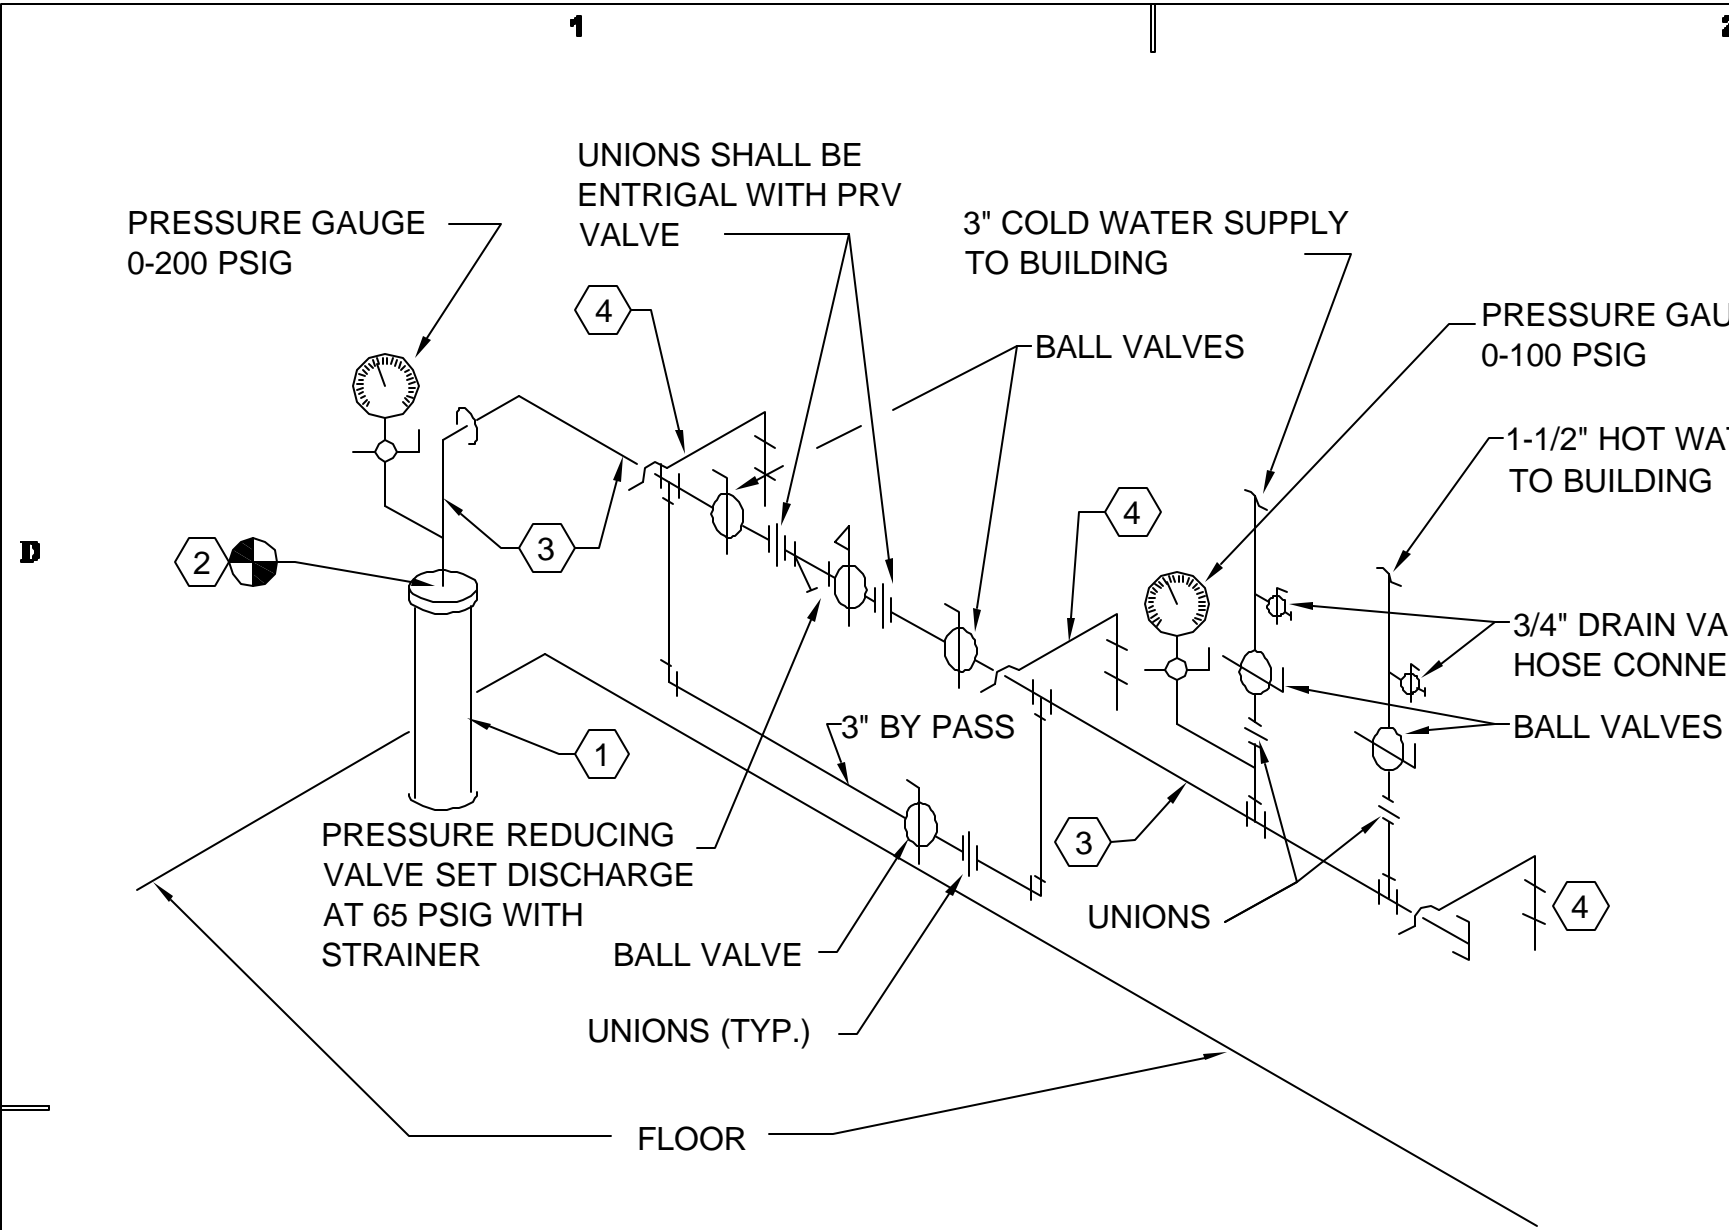


C1 NEW WATER PRESSURE REDUCING STATION DETAIL
SCALE: NONE

- 1 EXISTING 3"Ø DUCTILE IRON PIPE ENTRANCE TO BUILDING. SLEEVE AND DUCTILE IRON SHALL REMAIN.
- 2 NEW COUPLING FROM DUCTILE IRON PIPE TO COPPER PIPE. SEE RISER DETAIL A1/PD501.
- 3 NEW 3"Ø WATER HEADER AND PRV STATION. SEE C3/PE201.
- 4 SUPPORTS-ATTACH TO WALL. STRAP PIPING TO HORIZONTAL HEADER.

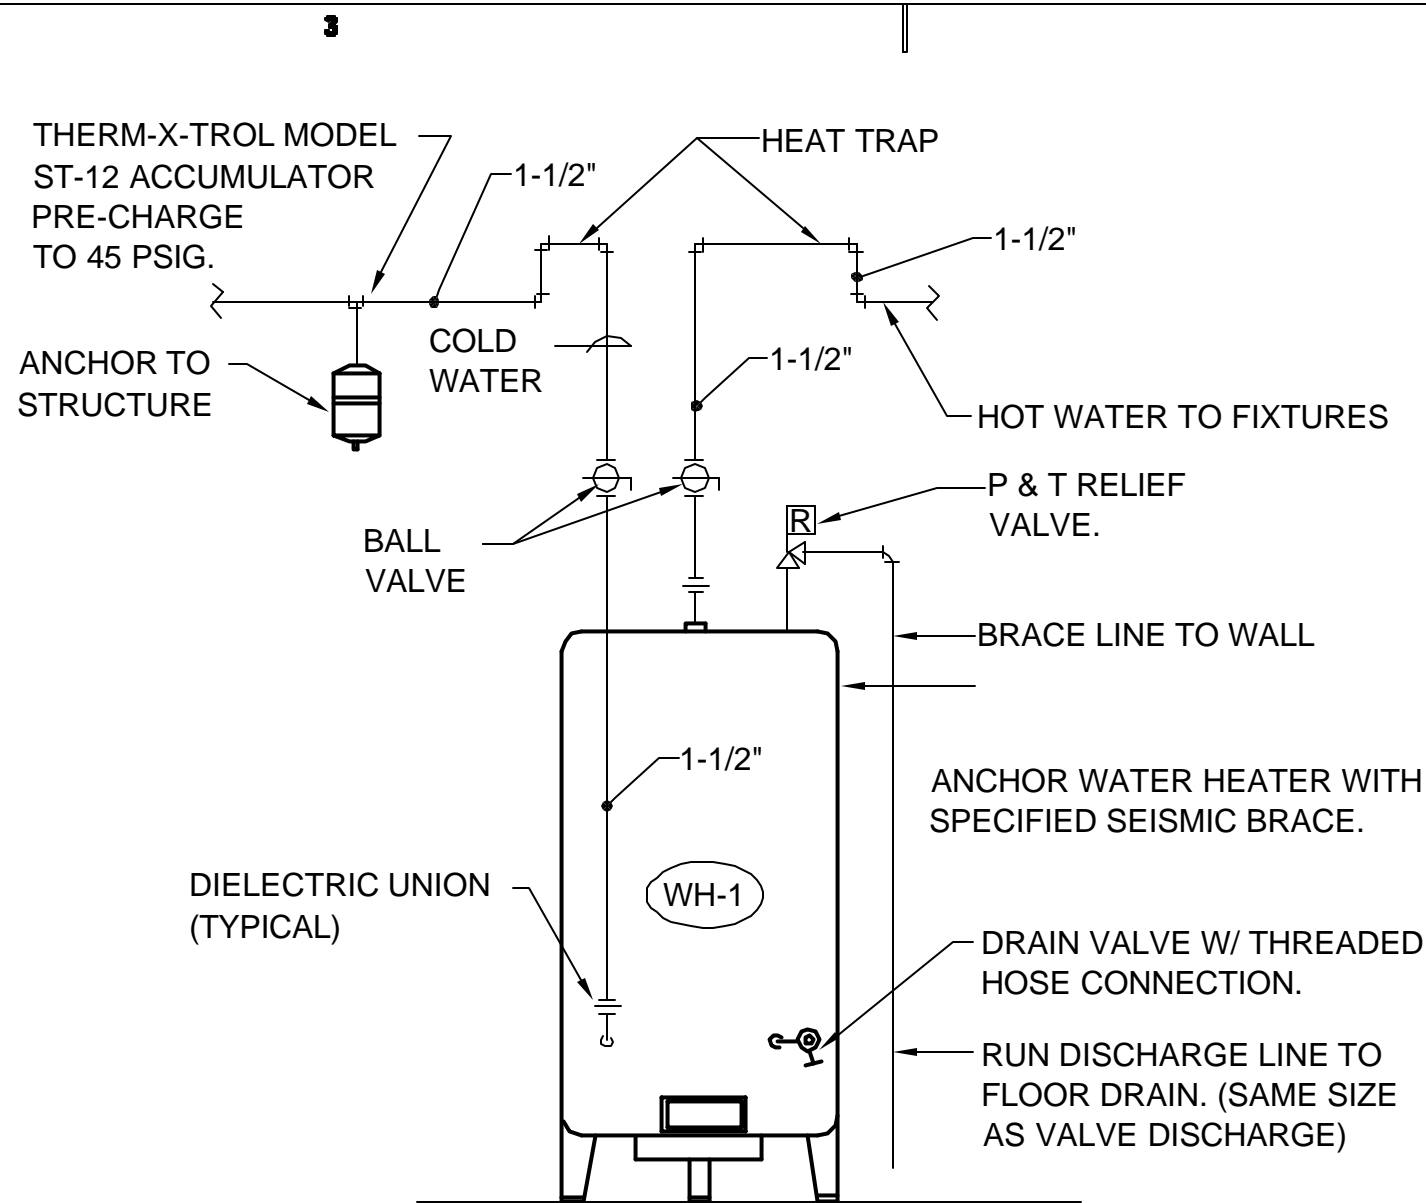

C3 ELECTRIC WATER HEATER DETAIL
SCALE: NONE

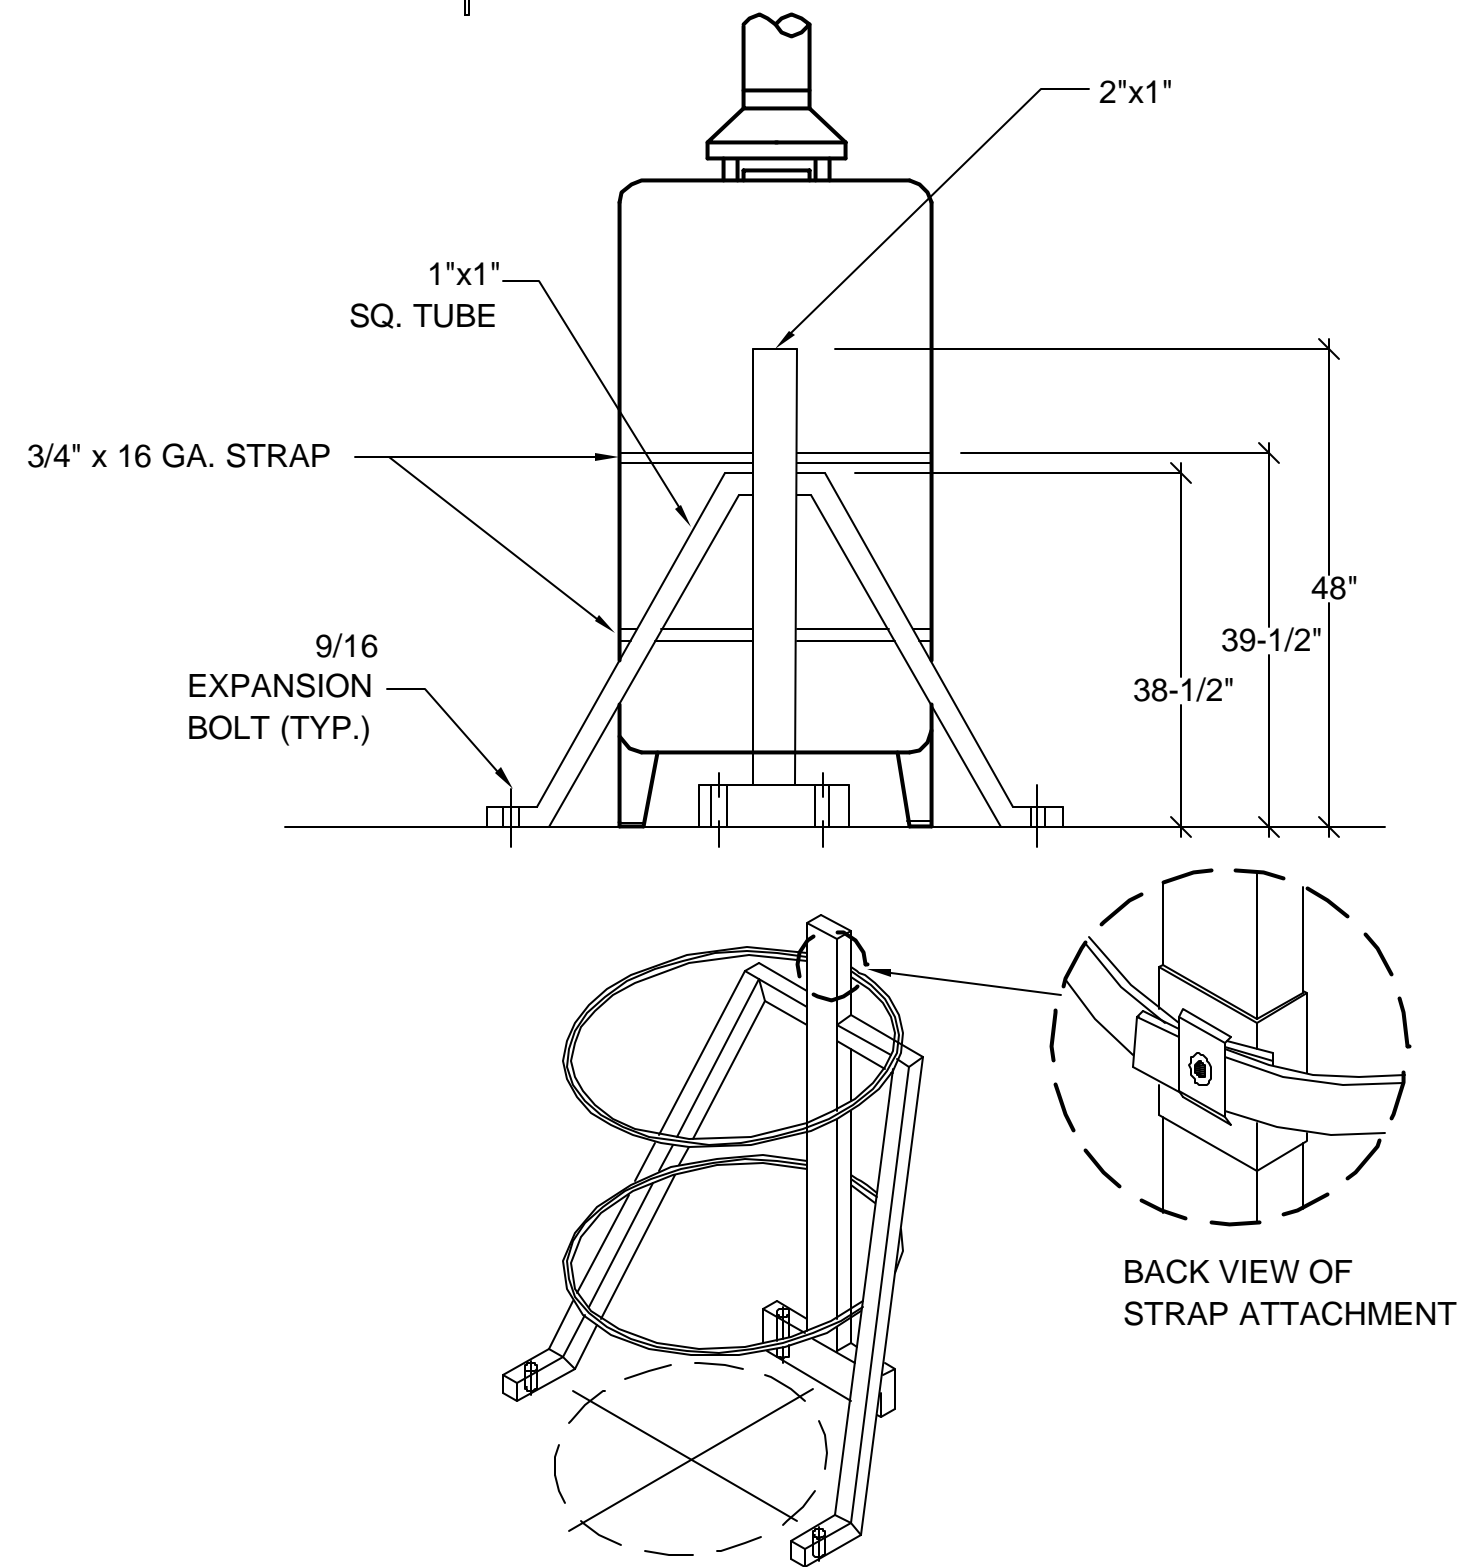


C4 WATER HEATER SEISMIC SUPPORT DETAIL
SCALE: NONE

WATER HEATER SCHEDULE							
SYMBOL	WATTAGE	GPH RECOVERY @ 100°F	STORAGE CAPACITY	KW INPUT	VOLTAGE	# OF ELEMENTS	MANUFACTURER
WH-1	18,000	73 GPH	82 GALLON	18	480/60/3Ø	3	STATE SB6-82-18

PLUMBING FIXTURE SCHEDULE (WATER)					
SYMBOL	FIXTURE	INDIVIDUAL LINE SIZES		REMARKS	
		C.W.	H.W.		
WC-1	WATER CLOSET	1"	-	WALL MOUNTED, FLUSH VALVE	1
WC-2	WATER CLOSET	1"	-	HANDICAPPED, WALL MTD. FV	1
L-1	LAVATORY	1/2"	1/2"	CABINET MOUNTED	2
L-2	LAVATORY	1/2"	1/2"	WALL MOUNTED	2
SS-1	SERVICE SINK	3/4"	3/4"	FLOOR MOUNTED	2
DF-1	DRINKING FOUNTAIN	1/2"	1/2"	FULLY RECESSED-REMOVE AND REPLACE WITH DF-2	3
DF-2	DRINKING FOUNTAIN	1/2"	1/2"	HANDICAPPED	1, 3
SC-1	SILL COCK	3/4"	-	NONE FREEZE TYPE	1
S-1	SINK	1/2"	1/2"	CABINET MOUNTED, STAINLESS STEEL	2
HB-1	HOSE BIBB	3/4"	-	WITH VACUUM BREAKER	1
KS-1	KITCHEN SINK	1/2"	1/2"	CABINET MOUNTED, STAINLESS STEEL 3 COMPARTMENT	2
BS-1	BREAKROOM SINK	1/2"	1/2"	CABINET MOUNTED, STAINLESS STEEL 2 COMPARTMENT	2
S-2	SINK	1/2"	1/2"	CABINET MOUNTED, STAINLESS STEEL 2 COMPARTMENT	2
S-3	LAB SINK	1/2"	1/2"	CABINET MOUNTED, STAINLESS STEEL 2 COMPARTMENT	2
S-4	SINK	1/2"	1/2"	SINGLE, FLOOR MOUNTED MECH. ROOM	2
U-1	URINAL	3/4"	-	HANDICAPPED	1
U-2	URINAL	3/4"	-	WALL MTD. FLUSH VALVE	1

- 1 EXISTING FIXTURES WITH NEW COLD WATER SUPPLY.
- 2 EXISTING FIXTURES WITH NEW HOT AND COLD WATER SUPPLY.
- 3 NEW FIXTURE ADDED.

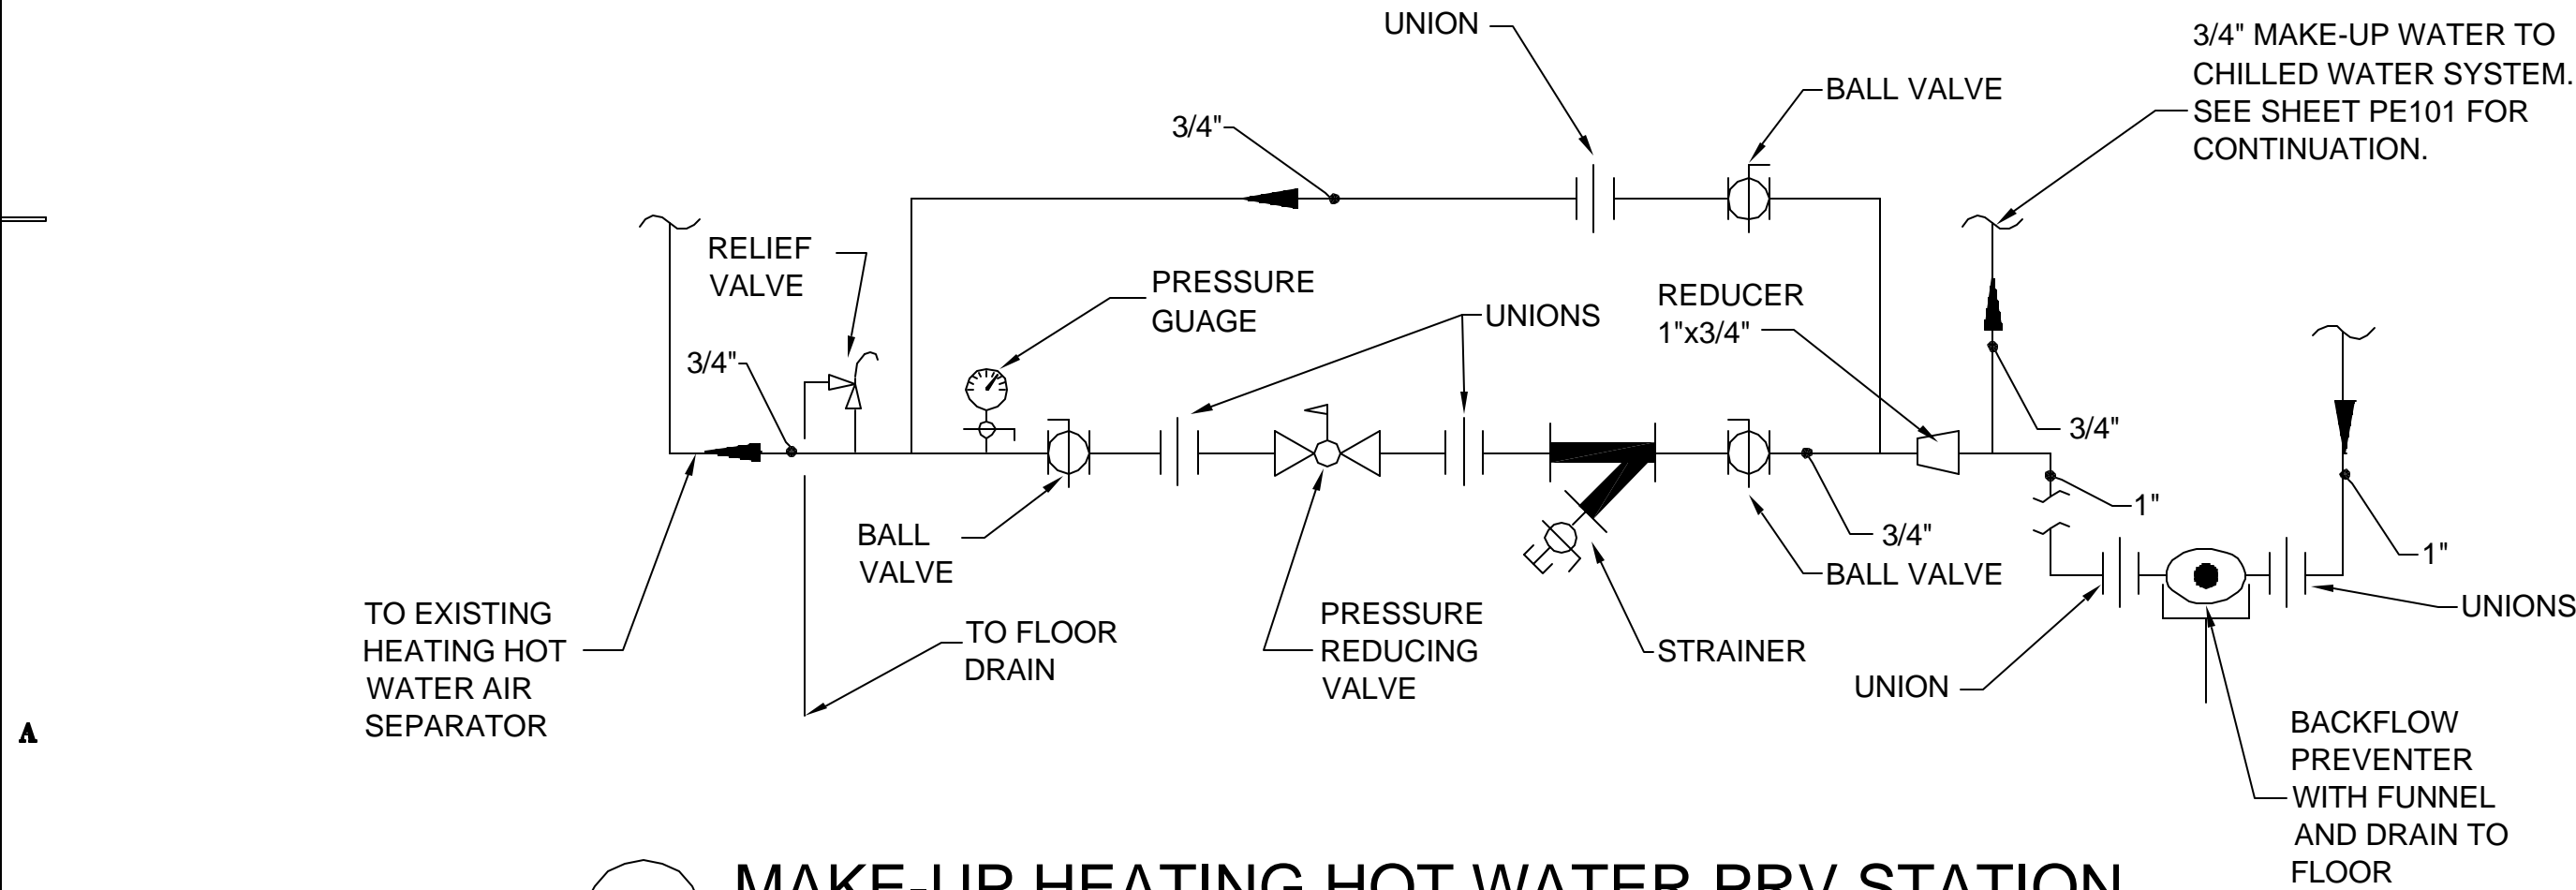

A1 MAKE-UP HEATING HOT WATER PRV STATION
SCALE: NONE

CONSULTANTS



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PROJECT NAME & ADDRESS

**DEPARTMENT OF
NATURAL RESOURCES
ADMIN. BUILDING
WATER SUPPLY
NETWORK REPLACEMENT**

DFCM# 04206500

SALT LAKE CITY, UTAH

MARK	DATE	REVISION

PROJECT MANAGER:

SLW

DRAWN BY:

STAFF

CHECKED BY:

SLW/WP

DATE:

01/12/05

WHW JOB NO.:

04048

SHEET TITLE



CULINARY PIPING
DETAILS

SHEET NO.

PE501



D1 LAVATORY NEW PIPING INSTALLATION
2ND FLOOR LAVATORIES
SCALE: NONE



D2 LAVATORY NEW PIPING INSTALLATION
3RD FLOOR LAVATORIES
SCALE: NONE




D4 TYPICAL SERVICE SINK
NEW PIPING INSTALLATION
SCALE: NONE



A1 TYPICAL DRINKING FOUNTAIN
NEW PIPING INSTALLATION
SCALE: NONE



A2 TYPICAL WATER CLOSET NEW
PIPING INSTALLATION FOR 1ST FLOOR
SCALE: NONE

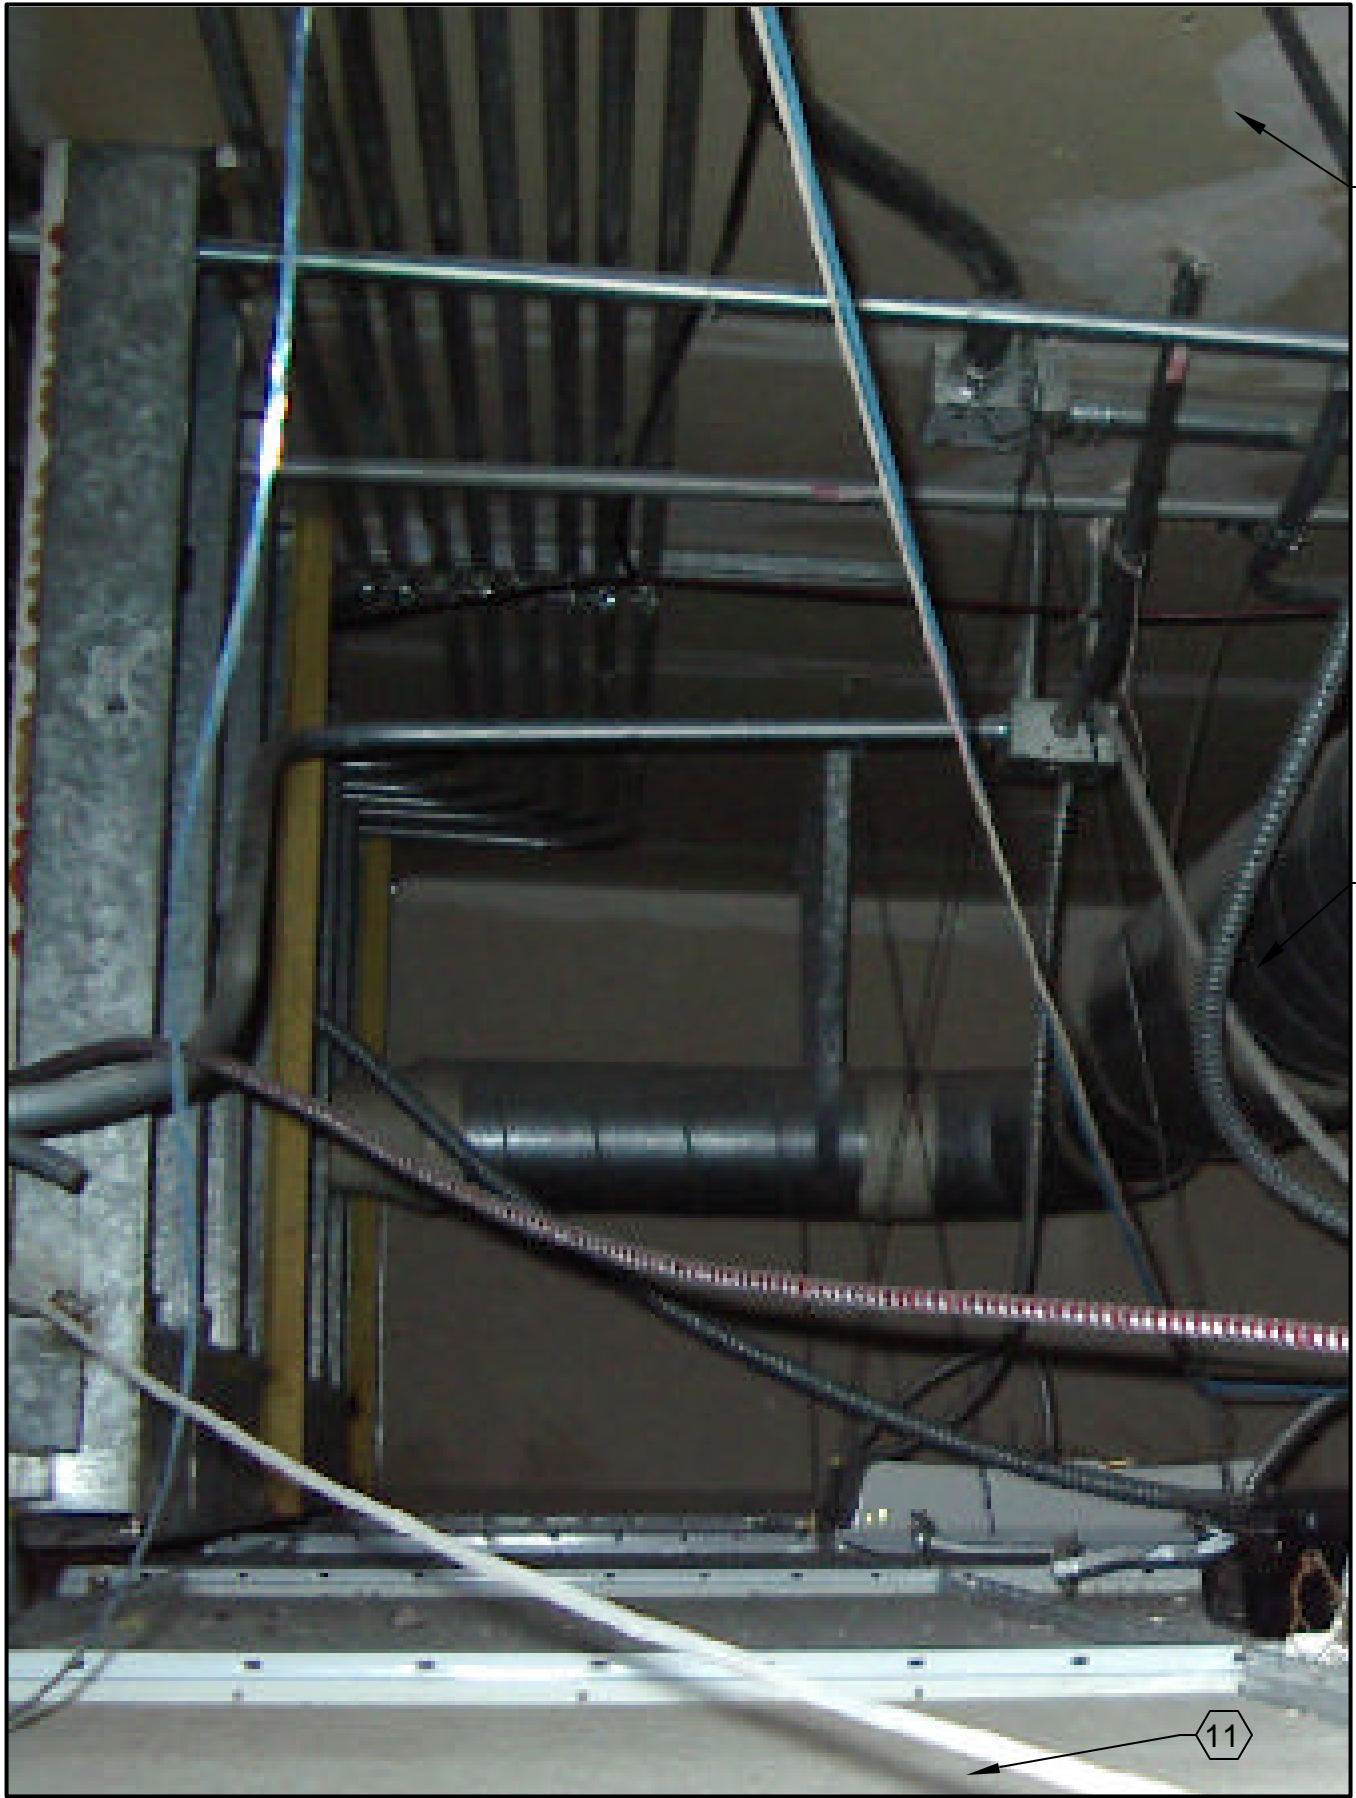

A4 TYPICAL CEILING SPACE FOR
ROUTING OF NEW PIPING
SCALE: NONE

SHEET NOTES

- 1 DRILL OPENINGS THRU EXISTING FLOORS.
- 2 NEW STAINLESS STEEL OR CHROME PLATED HOT AND COLD WATER PIPING.
- 3 NEW STAINLESS STEEL OR CHROME PLATED SLEEVE OVER COPPER PIPING.
- 4 CONNECT NEW HOT AND COLD WATER PIPING TO EXISTING LAVATORY FAUCET.
- 5 EXISTING CABINET MOUNTED LAVATORIES SHALL REMAIN.
- 6 PROVIDE ESCUTCHEON PLATES WHERE NEW PIPING PENETRATES FLOOR.
- 7 PROVIDE IN-LINE STOPS.
- 8 CONNECT NEW PIPING INTO EXISTING FAUCET BEHIND WALL.
- 9 EXISTING PLUMBING FIXTURES SHALL REMAIN.
- 10 TYPICAL CEILING SPACE WHERE NEW COPPER PIPING SHALL BE LOCATED AND DISTRIBUTED.
- 11 EXISTING LAY-IN CEILING.
- 12 EXISTING FIRE RATED CEILING.
- 13 CONNECT TO EXISTING FLUSH VALVE FROM BEHIND WALL.
- 14 ROUTE NEW TUBING AS HIGH AS POSSIBLE UNDER CABINET OUT OF SIGHT.

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PROJECT NAME & ADDRESS

**DEPARTMENT OF
NATURAL RESOURCES
ADMIN. BUILDING
WATER SUPPLY
NETWORK REPLACEMENT**

DFCM# 04208500

SALT LAKE CITY, UTAH

MARK	DATE	REVISION
1	1/12/05	LOCATE PIPING CONCEALED UNDER COUNTER WITH ONLY TWO FLOOR PENETRATIONS FOR EACH BANK OF LAVATORIES

PROJECT MANAGER:
SLW

DRAWN BY:
STAFF

CHECKED BY:
SLW/WP

DATE:
01/12/05

WHW JOB NO.:
04048

SHEET TITLE:
**CULINARY PIPING
INSTALLATION DETAILS**


NOTE:

1. ROUTE NEW COPPER HOT AND COLD WATER PIPING ABOVE LAY-IN OR HARD CEILINGS AND BELOW FIRE RATED HARD CEILING. COORDINATE WITH ALL EXISTING MATERIALS, LIGHTS, CONDUIT, DUCT ETC. DRAWING ARE DIAGRAMMATIC AND NOT SUBJECT TO EXISTING CONDITIONS. CONTRACTOR SHALL FIELD VERIFY ROUTING BEFORE INSTALLATION. NO EXTRA COST WILL BE ALLOWED FOR CONTRACTOR'S FAILURE TO DO THIS VERIFICATION.
2. ALL NEW PIPING FOR 2ND AND 3RD FLOOR FIXTURES SHALL BE PROVIDED FROM THE CEILING SPACE BELOW. ALL OPENINGS THROUGH FIRE RATED CEILINGS SHALL BE SEALED AIR TIGHT WITH FIRE RESISTANCE SEALER.

PROFESSIONAL ENGINEER
01/12/05
WINWARD M. PACKER
No. 336080
STATE OF UTAH

SHEET NO.
PE502

D
C
B
A

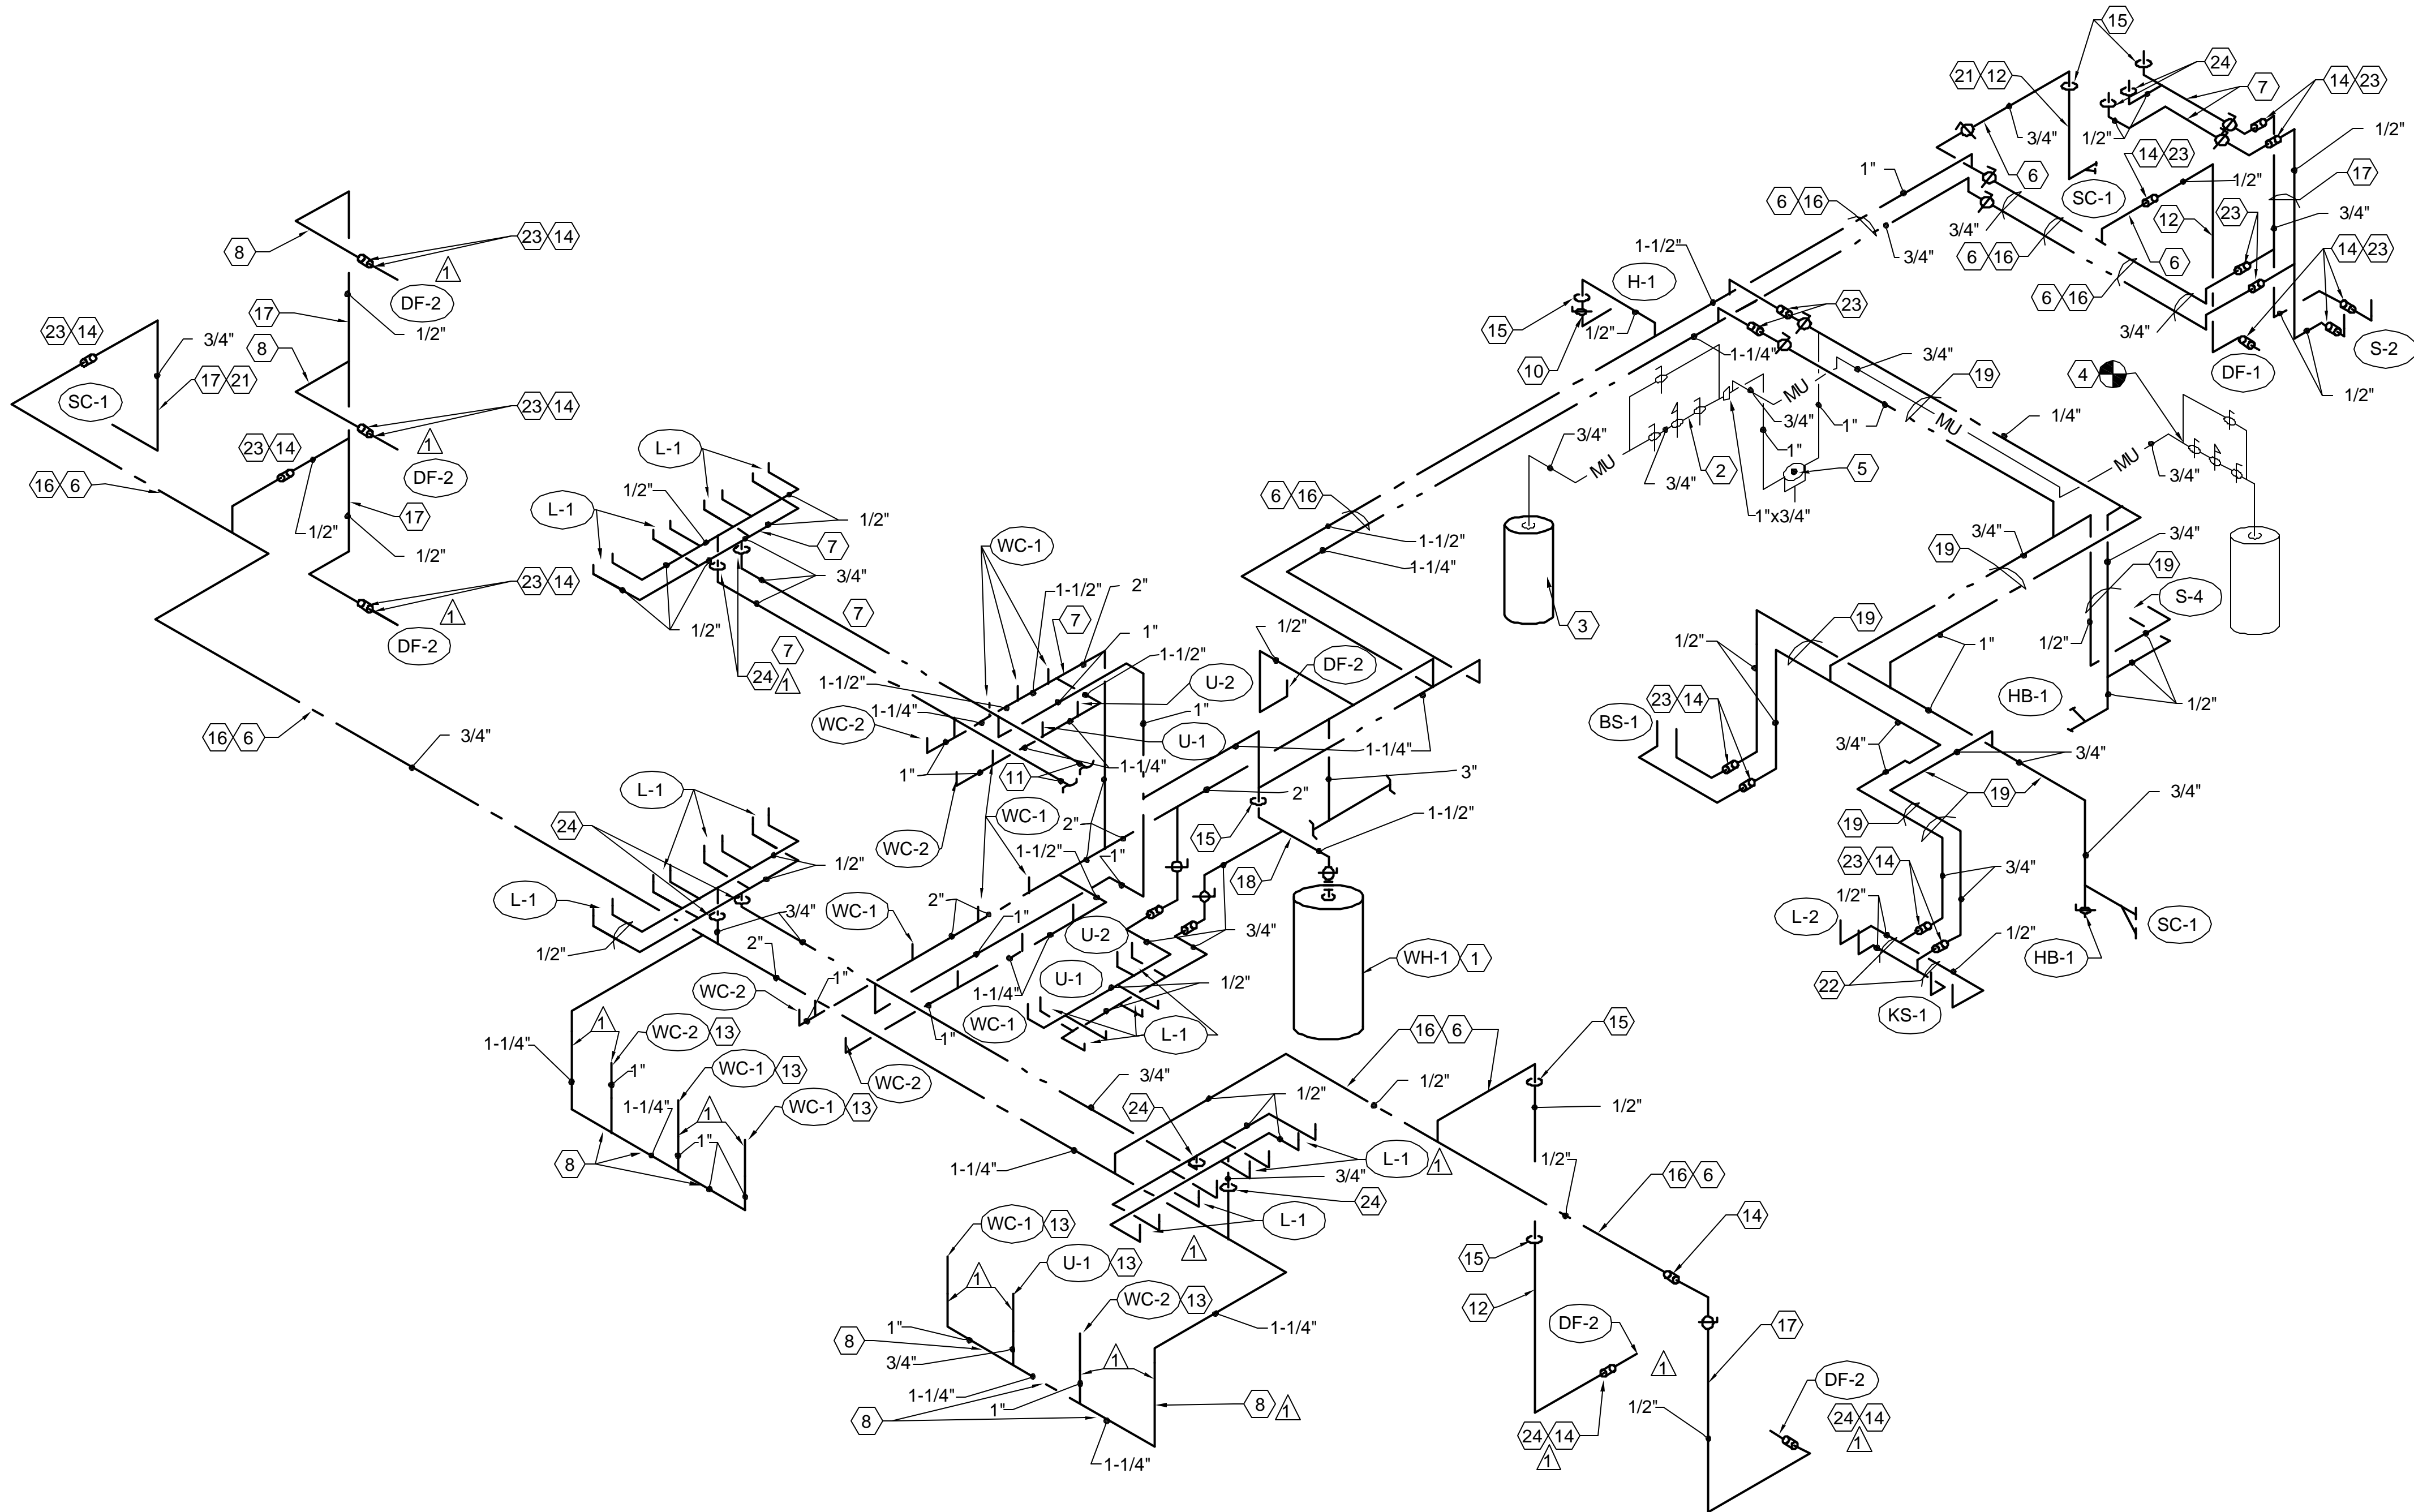

HOT AND COLD PIPING ISOMETRIC
SCALE: NONE

SHEET NOTES

- NEW ELECTRIC HOT WATER HEATER. SEE DETAIL C3/PE501.
- NEW HEATING HOT WATER MAKE-UP WATER LINE AND PRV STATION. SEE DETAIL A1/PE501.
- EXISTING HEATING HOT WATER SEPARATOR.
- EXISTING CHILLED WATER AIR SEPARATOR AND PRV STATION. CONNECT TO NEW PIPING AS SHOWN.
- NEW 1" BACKFLOW PREVENTOR TO SERVE BOTH CHILLED AND HOT WATER MAKE-UP WATER SYSTEMS. SEE DETAIL A1/PE501.
- ROUTE CULINARY HOT AND COLD WATER PIPING IN CEILING OF FIRST FLOOR TO SERVE BOTH 1ST AND 2ND FLOORS.
- ROUTE CULINARY HOT AND COLD WATER PIPING IN 2ND FLOOR CEILING SPACE TO SERVE 3RD FLOOR.
- ROUTE COLD WATER PIPING WITHIN WALL.
- EXISTING 1ST FLOOR LAVATORIES SHALL BE CONNECTED TO NEW HOT AND COLD WATER PIPING FROM CUSTODIAL CLOSET THRU THE WALL AND UNDER CABINET. PIPING EXPOSED UNDER THE COUNTER SHALL BE STAINLESS STEEL OR CHROME PLATED. ROUTE AS HIGH AS POSSIBLE UNDER THE COUNTER.
- PIPING DROP TO COMPUTER ROOM SHALL BE EXPOSED AND INSULATED WITH A PVC JACKET COVERING.
- ROUTE TO FOUR LAVATORIES, PIPE AS INDICATED FOR THE LAVATORIES SHOWN ON THE OTHER END OF THIS PIPING.
- DROP DOWN FROM 1ST FLOOR CEILING. EXPOSED DROP SHALL BE INSULATED WITH A PVC JACKET COVERING.
- RISERS TO WATER CLOSETS AND URINAL ON FIRST FLOOR SHALL BE ROUTED IN THE WALL.
- WALL PENETRATIONS-PROVIDE WALL PLATES.
- CEILING PENETRATION PROVIDE CEILING PLATES.
- ROUTE IN 1ST FLOOR CEILING SPACE-INSULATE ONLY, PVC JACKET NOT REQUIRED.
- ROUTE PIPING IN STAIRWELL. INSULATE WITH PVC JACKET COVERING.
- PIPING IN CUSTODIAL CLOSET SHALL BE INSULATED ONLY.
- PIPING IN MECHANICAL ROOM SHALL BE INSULATED ONLY.
- ROUTE HOT WATER PIPING OVER COLD WATER PIPING SO BOTH ARE SUPPORTED FROM WALL.
- PIPING DROP TO SILLCOCK SHALL BE INSULATED WITH PVC JACKET COVERING.
- ROUTE PIPING EXPOSED ON WALL OR IN CABINET OF TRIPLE COMPARTMENT SINK. PIPING IN KITCHEN SHALL BE CHROME PLATED, COPPER, OR STAINLESS STEEL.
- WALL PENETRATIONS. SEAL AROUND PIPING.
- FLOOR PENETRATION-PROVIDE ESCUTCHEON PLATES.
- COLD WATER HEADER. SEE DETAIL C1/PE501 AND C3/PE201.

NOTE:

- ROUTE NEW COPPER HOT AND COLD WATER PIPING ABOVE LAY-IN OR HARD CEILINGS AND BELOW FIRE RATED HARD CEILING. COORDINATE WITH ALL EXISTING MATERIALS, LIGHTS, CONDUIT, DUCT ETC. DRAWING ARE DIAGRAMMATIC AND NOT SUBJECT TO EXISTING CONDITIONS. CONTRACTOR SHALL FIELD VERIFY ROUTING BEFORE INSTALLATION. NO EXTRA COST WILL BE ALLOWED FOR CONTRACTOR'S FAILURE TO DO THIS VERIFICATION.
- ALL NEW PIPING FOR 2ND AND 3RD FLOOR FIXTURES SHALL BE PROVIDED FROM THE CEILING SPACE BELOW. ALL OPENINGS THROUGH FIRE RATED CEILINGS SHALL BE SEALED AIR TIGHT WITH FIRE RESISTANCE SEALER.

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PROJECT NAME & ADDRESS

**DEPARTMENT OF
NATURAL RESOURCES
ADMIN. BUILDING
WATER SUPPLY
NETWORK REPLACEMENT**

DFCM# 04206500

SALT LAKE CITY, UTAH

MARK	DATE	REVISION
1	1/12/05	COVERING OF PIPING

PROJECT MANAGER:

SLW

DRAWN BY:

STAFF

CHECKED BY:

SLW/WP

DATE:

01/12/05

WHW JOB NO.:

04048

SHEET TITLE

PIPING ISOMETRIC
PLAN

SHEET NO.

PE901

